FIRE ALARM CONTROL PANEL

MANUAL PULL STATION

SMOKE DETECTOR

DUCT SMOKE DETECTOR

TAMPER SWITCH

FLOW SWITCH SPEAKER STROBE

STROBE ONLY

<u>REFERENCES</u>

KEYED NOTE

REVISION DELTA

A. ALL CONTRACT DOCUMENTS ARE PART OF THE FIRE ALARM WORK INSOFAR AS THEY APPLY, AS IF REFERRED TO IN FULL. SEE CONTRACT DOCUMENTS OF ALL OTHER DISCIPLINES FOR WORK TO BE PERFORMED BY THE ELECTRICAL CONTRACTOR.

GENERAL NOTES

- B. DO NOT SCALE FIRE PROTECTION DRAWINGS. DRAWINGS ARE MADE ON A SMALL SCALE, DEVICES AND EQUIPMENT ARE SHOWN IN THEIR APPROXIMATE LOCATION, UNLESS SPECIFICALLY DIMENSIONED. VERIFY ALL DIMENSIONS ON THE PROJECT. REFER TO CONTRACT DOCUMENTS OF ALL OTHER DISCIPLINES FOR DIMENSIONS.
- C. MATERIALS, DIMENSIONS, WALL THICKNESS, ROUGH OPENINGS, PATTERNS, AND THE LIKE SHALL BE FIELD VERIFIED BY THE CONTRACTOR. ANY DISCREPANCIES SHALL BE BROUGHT TO THE ATTENTION OF THE ARCHITECT AND ENGINEER PRIOR TO COMMENCING WITH THE WORK.
- D. PRIOR TO ROUGH-IN OF ANY FIRE PROTECTION EQUIPMENT THE CONTRACTOR SHALL COORDINATE WITH ALL CONSTRUCTION DOCUMENTS AND ALL OTHER TRADES TO PREVENT ANY INTERFERENCES. PREPARE COORDINATION DRAWINGS AS REQUIRED IN CONJUNCTION WITH OTHER TRADES TO PREVENT INTERFERENCES. ANY MODIFICATIONS TO WORK INSTALLED DUE TO LACK OF COORDINATION SHALL BE FULLY BORNE BY THE CONTRACTOR.
- E. CONTRACTOR SHALL MAINTAIN A COMPLETE SET OF AS-BUILT DRAWINGS. AS-BUILT SET OF DRAWINGS SHALL BE UPDATED DAILY AND SHALL DOCUMENT THE ACTUAL INSTALLED CONDITION OF THE ENTIRE FIRE ALARM INSTALLATION. AS-BUILT SET OF DRAWINGS SHALL BE AVAILABLE AT ALL TIMES ON THE SITE FOR INSPECTION BY CODE OFFICIALS, OWNER, ARCHITECT, AND ENGINEER.
- F. OBTAIN ALL PERMITS, COORDINATE, FURNISH, INSTALL, CONNECT AND TEST ALL FIRE ALARM EQUIPMENT REQUIRED FOR ALL THE SYSTEMS INSTALLED UNDER THIS CONTRACT TO INSURE

RECALLED TO THE FLOOR ON WHICH THE ELEVATOR MACHINE ROOM IS LOCATED.

- COMPLETE AND FULLY OPERATIONAL SYSTEMS. G. INSTALL ALL EQUIPMENT PER MANUFACTURER'S RECOMMENDATIONS.
- H. ALL FIRE ALARM CONDUCTOR SHALL BE ROUTED IN CONDUIT. CONDUIT SIZE SHALL BE 3/4" MINIMUM. FIRE ALARM SYSTEM CONDUIT SHALL BE RED IN COLOR. I. UPON ACTIVATION OF SMOKE DETECTOR IN THE ELEVATOR MACHINE ROOM, ELEVATOR SHALL NOT BE
- J. ALL FIRE ALARM PROGRAMMING MUST BE ACCOMPLISHED BY THE CURRENT VA BOISE FIRE ALARM MAINTENANCE CONTRACTOR. THE CURRENT BOISE FIRE ALARM MAINTENANCE CONTRACTOR IS FIRE SENTRY SYSTEMS, Inc. 208-887-4774
- K. THE SAME CONTRACTOR (FIRE SENTRY) THAT PERFORMS THE INSTALLATION WILL PROVIDE THE OWNER/ OWNERS REPRESENTATIVE WITH INSTRUCTION AS HOW TO MANAGE, CONTROL, AND PROGRAM THE INSTALLED FIRE ALARM SYSTEM.

FIRE ALARM DRAWING INDEX

FIRE ALARM LEGEND AND SYMBOLS

GROUND FLOOR FIRE ALARM DEMOLITION PLAN

FIRST FLOOR FIRE ALARM DEMOLITION PLAN

SECOND FLOOR FIRE ALARM DEMOLITION PLAN THIRD FLOOR FIRE ALARM DEMOLITION PLAN

THIRD FLOOR FIRE ALARM DEMOLITION PLAN - BASE BID

PENTHOUSE FIRE ALARM DEMOLITION PLAN

GROUND FLOOR FIRE ALARM PLAN


FIRST FLOOR FIRE ALARM PLAN SECOND FLOOR FIRE ALARM PLAN

THIRD FLOOR FIRE ALARM PLAN

THIRD FLOOR FIRE ALARM PLAN-BASE BID

FIRE ALARM RISER DIAGRAM AND DETAILS

Pictorial Representation of Fire Alarm Interface with Elevators

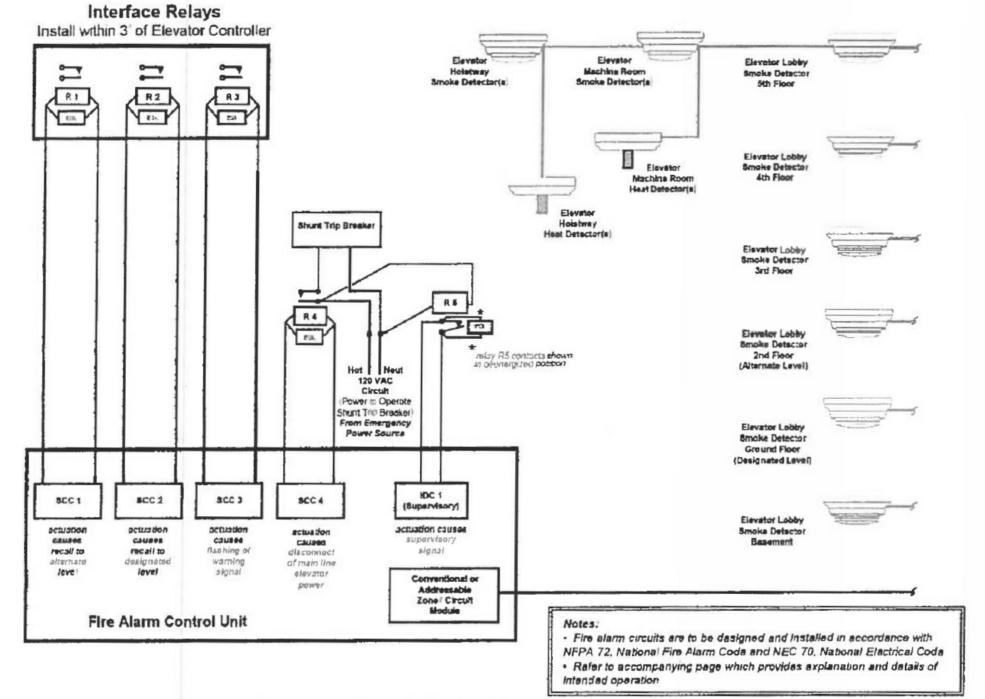

AMY K. DOCKTER, P.E. C.W. MOORE PLAZA 250 S. 5TH ST

BOISE, IDAHO PHONE: 208-343-4635 FAX: 208-343-1858

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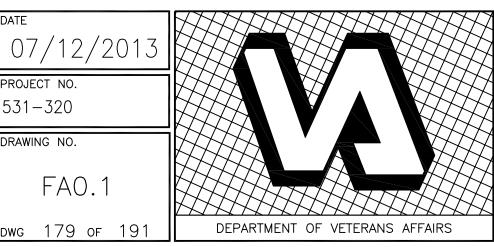
BOISE VAMC FIRE ALARM LEGEND BUILDING 67 EXPANSION AND SYMBOLS APPROVED: CHIEF OF FACILITY MANAGEMENT SERVICE BUILDING NUMBER

APPROVED: MEDICAL CENTER DIRECTOR

531-320 DRAWING NO.


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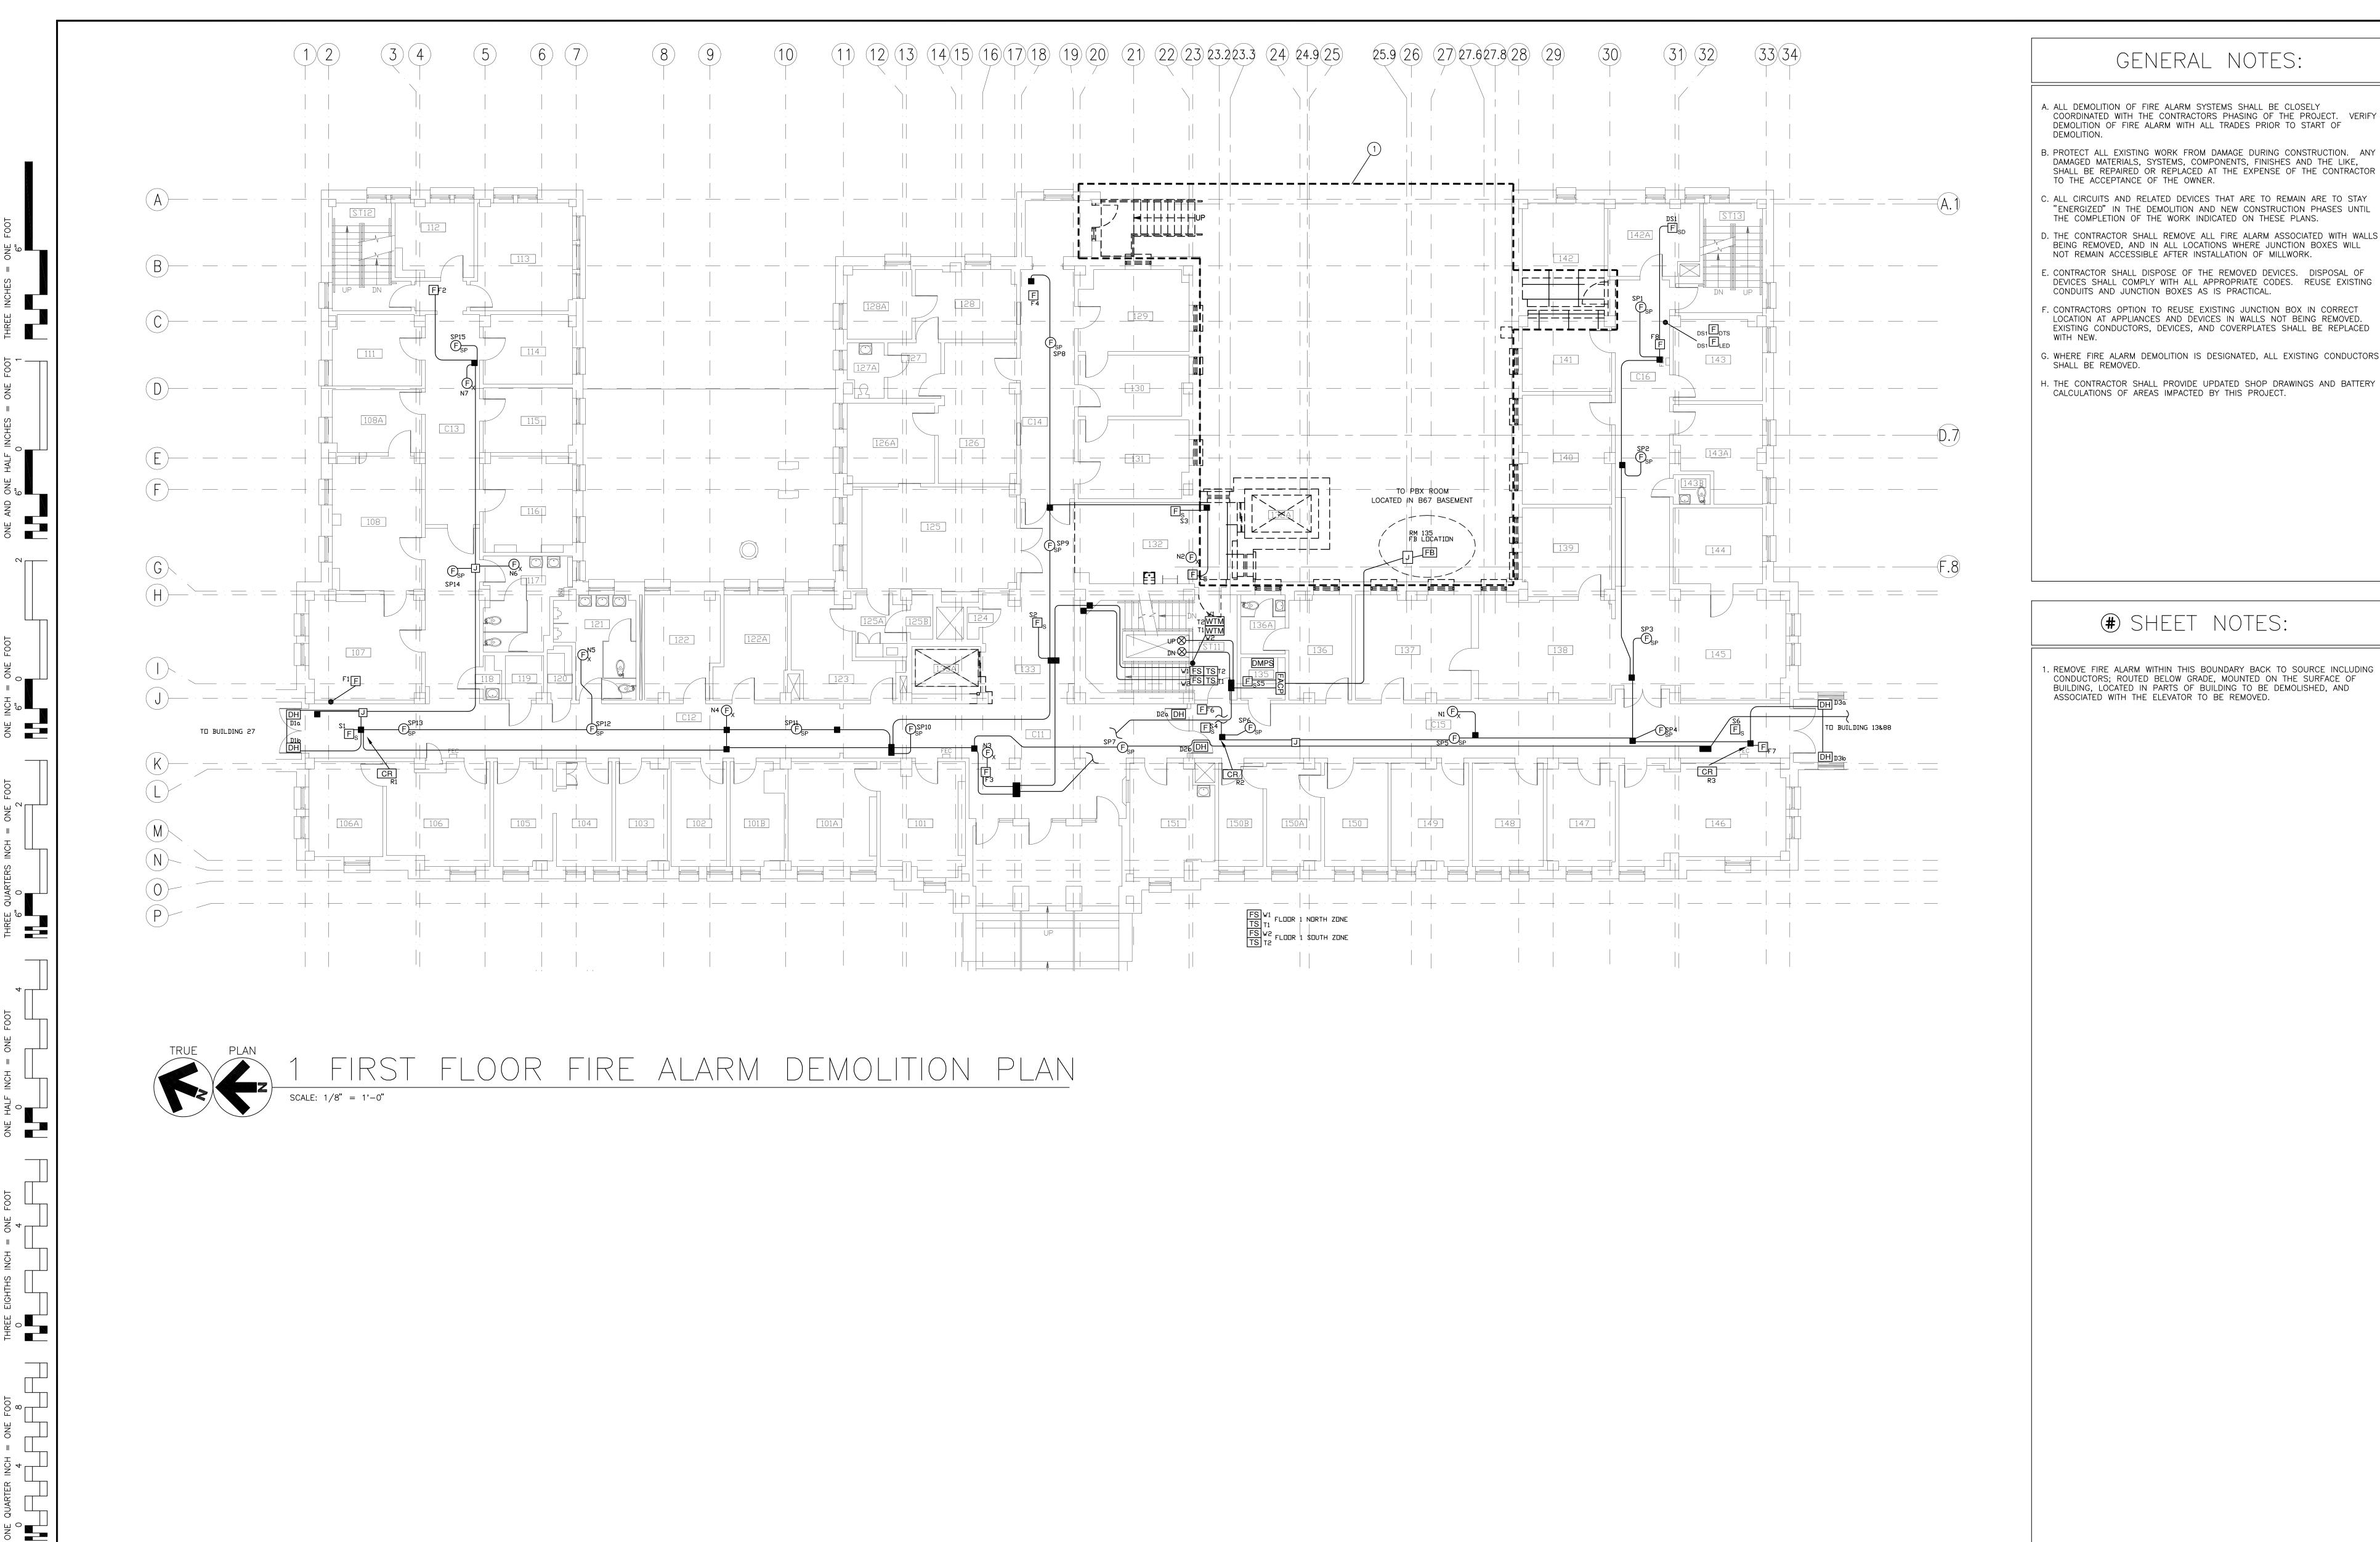
RJL




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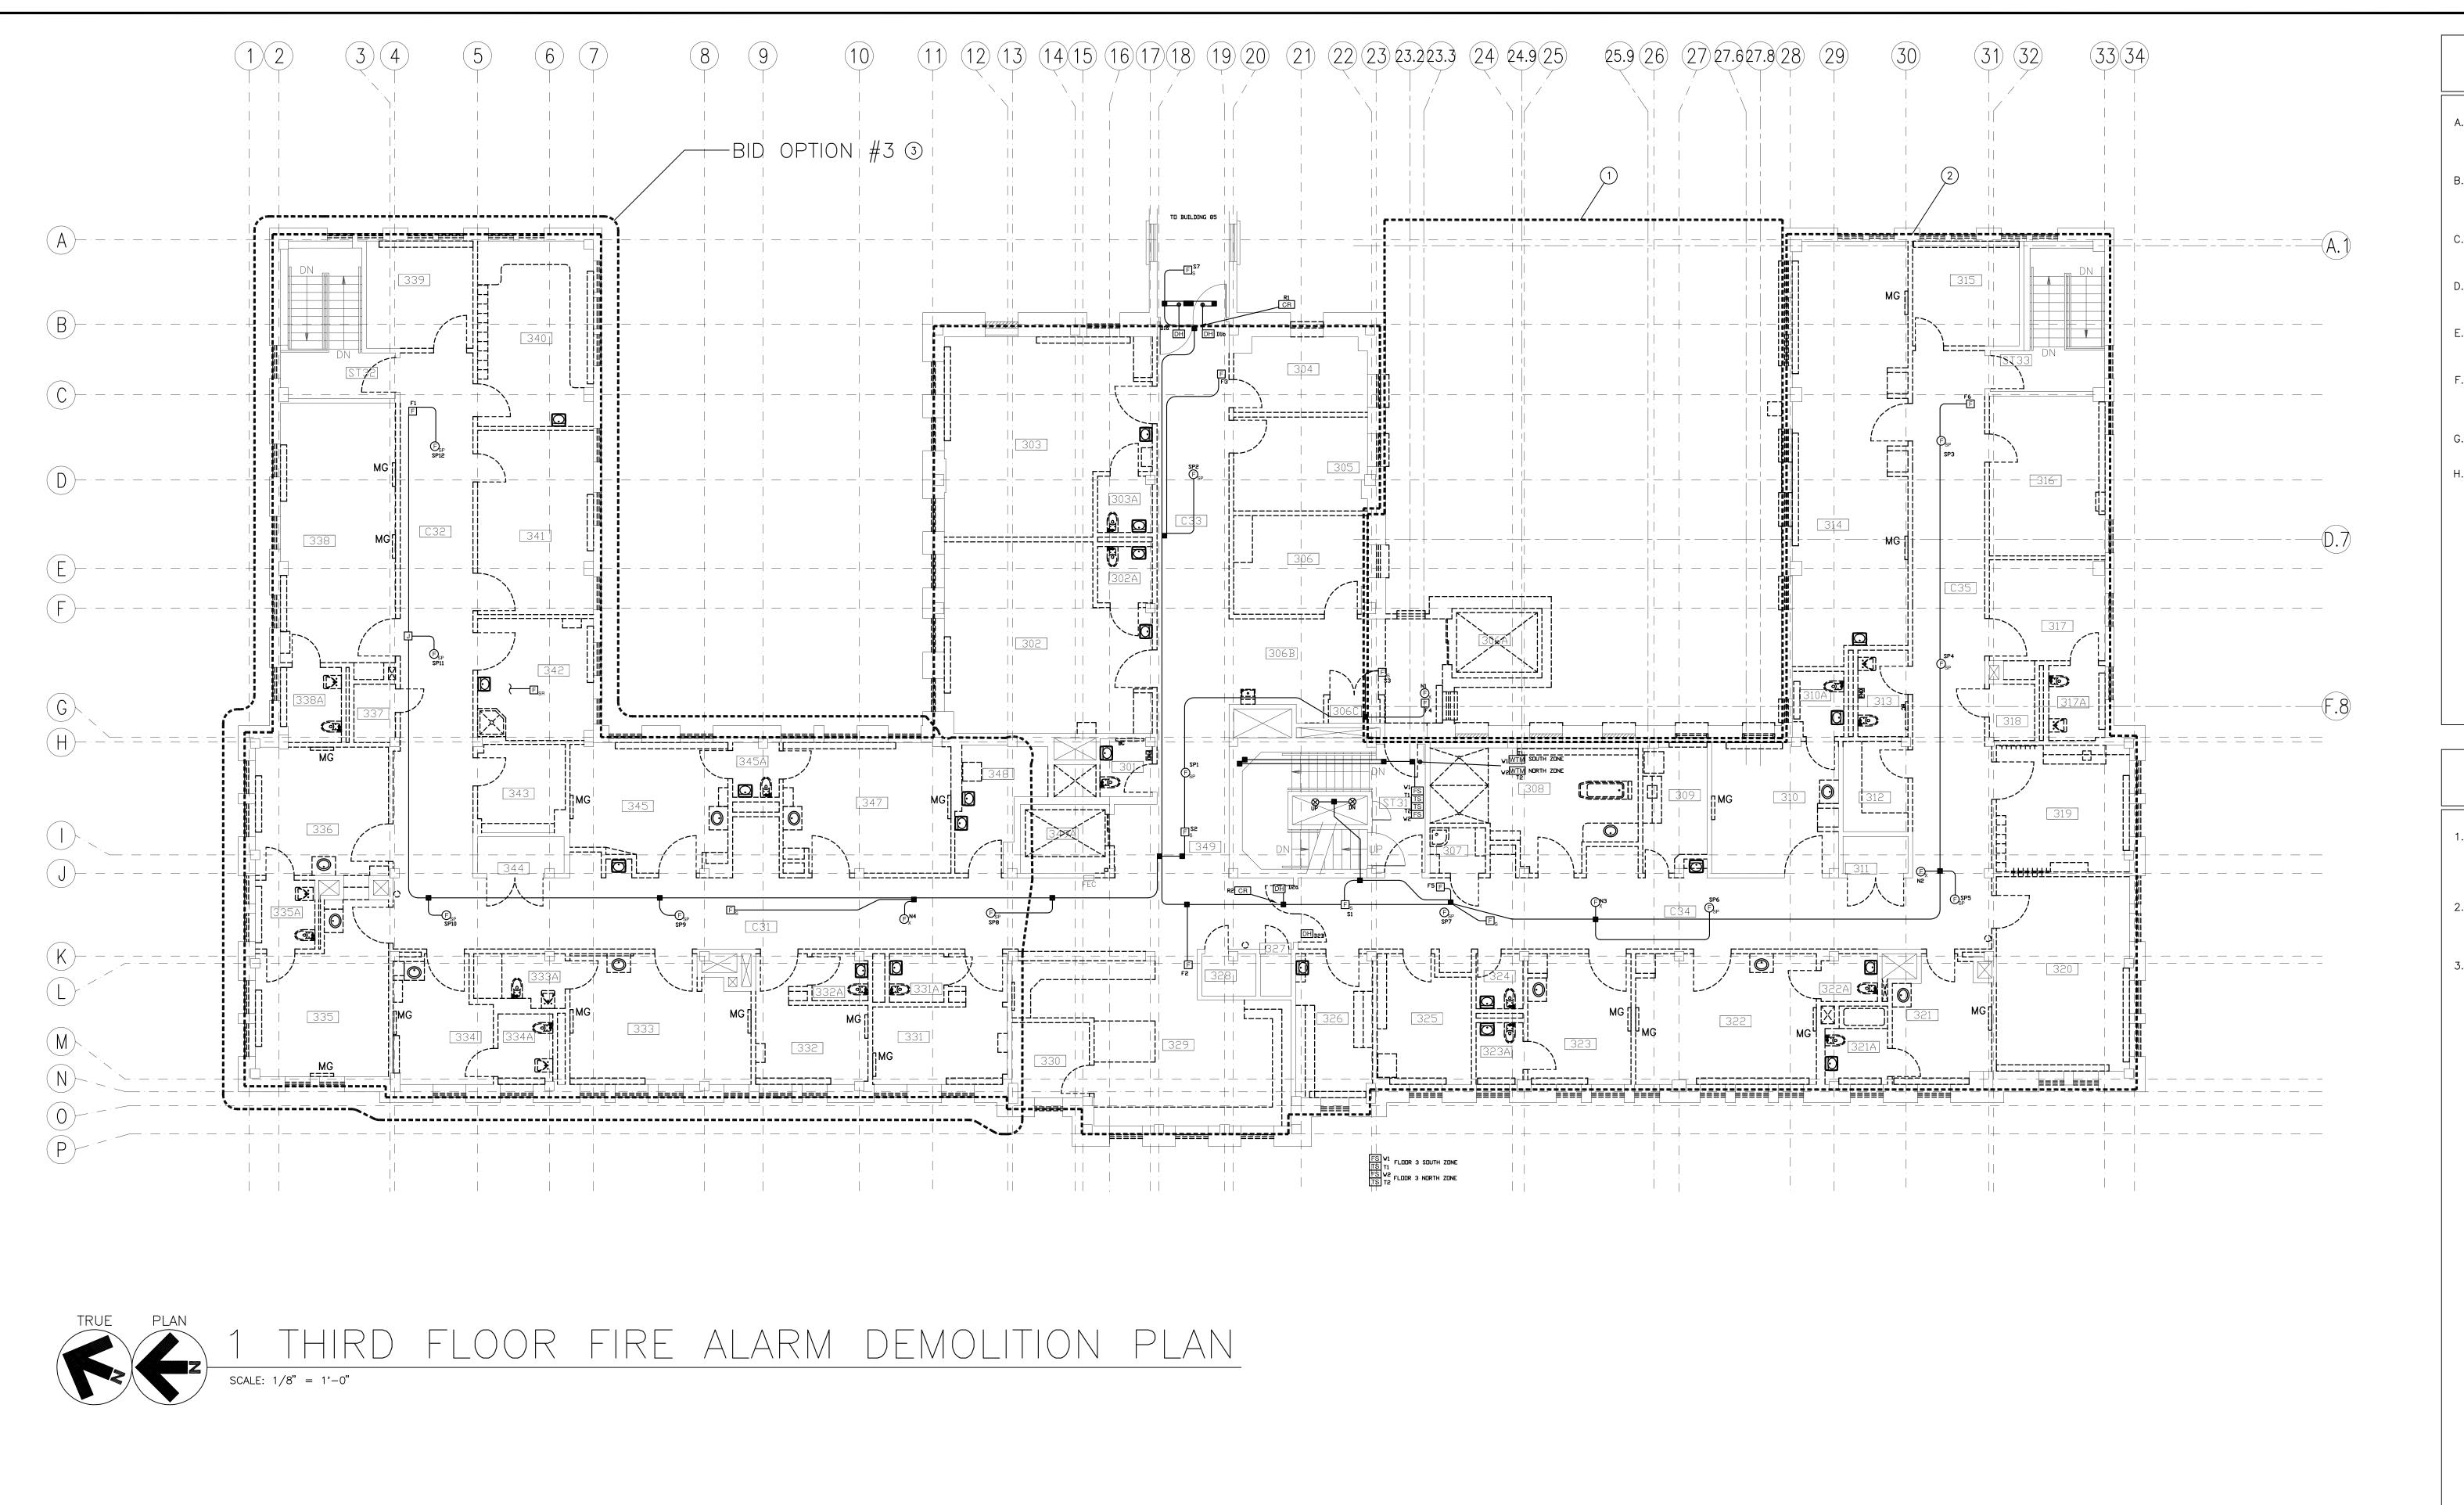
C.W. MOORE PLAZA 250 S. 5TH ST. BOISE, ID 83702 (208) 343-4635 FAX (208) 343-1858



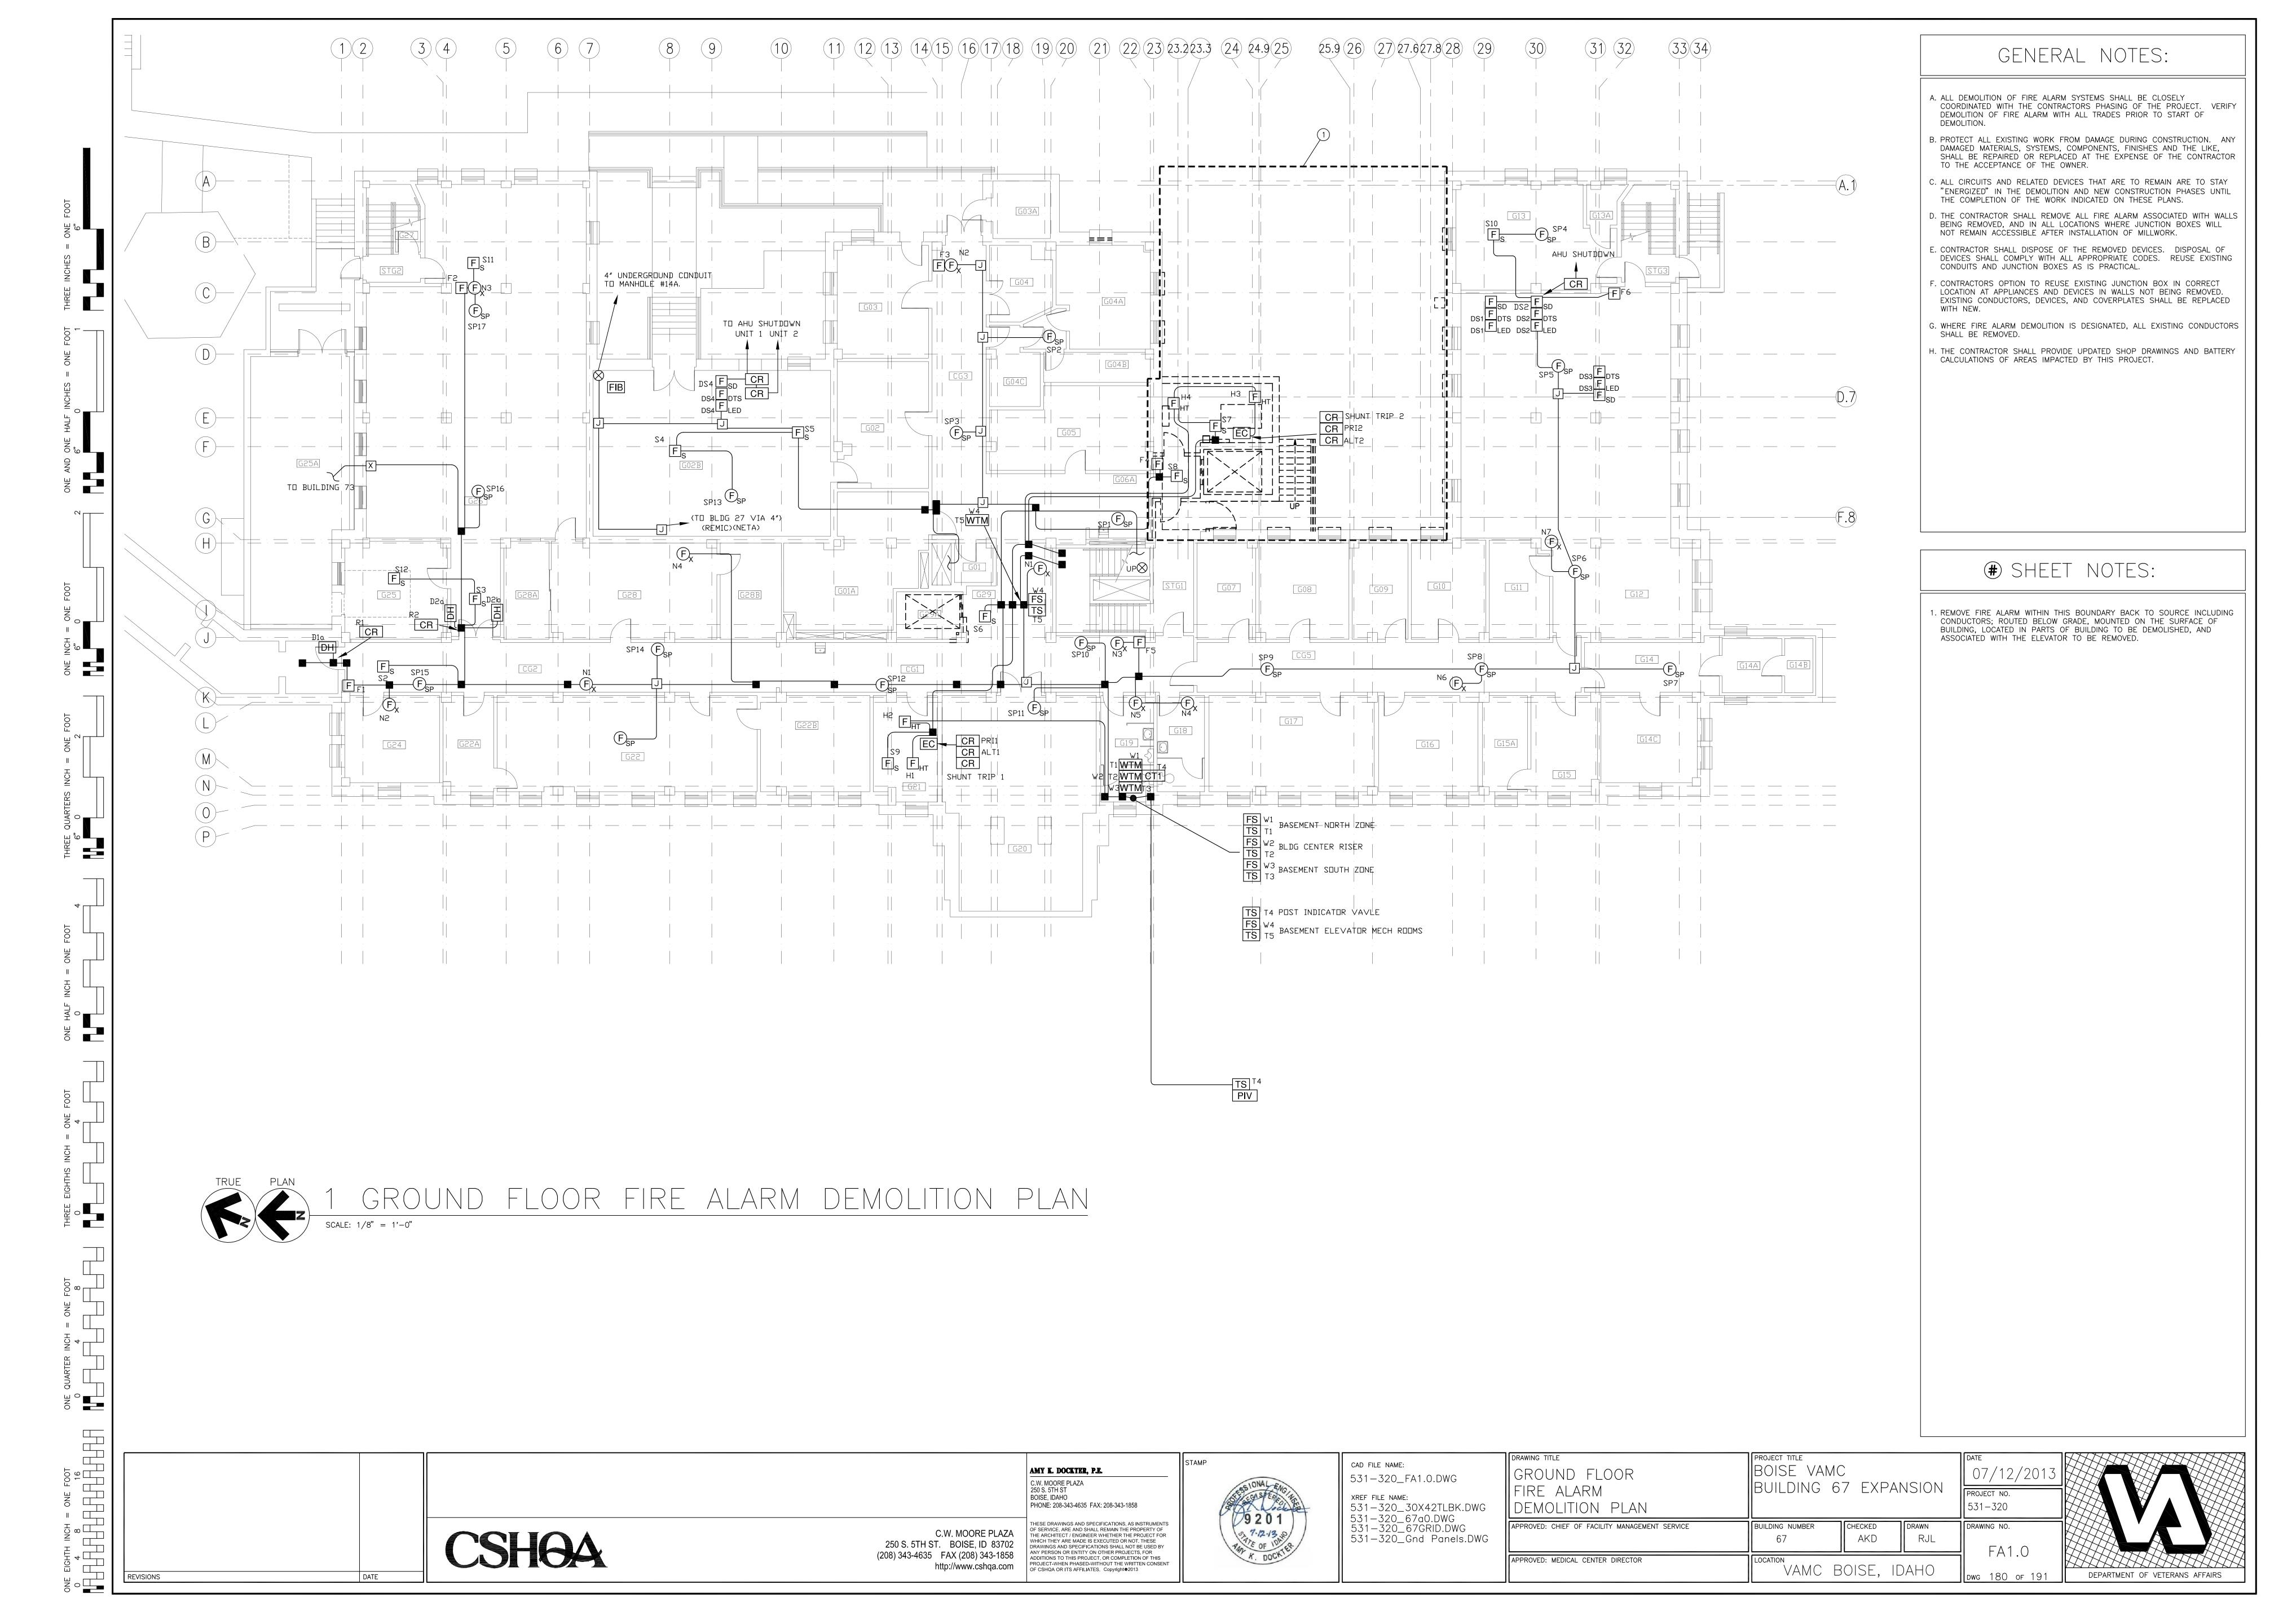

PRAWING TITLE CAD FILE NAME: BOISE VAMC AMY K. DOCKTER, P.E. FIRST FLOOR 531-320_FA1.1.DWG C.W. MOORE PLAZA 250 S. 5TH ST BUILDING 67 EXPANSION FIRE ALARM XREF FILE NAME: BOISE, IDAHO 531-320_30X42TLBK.DWG 531-320_67a1.dwg 531-320_67GRID.DWG 531-320_1st Panels.DWG DEMOLITION PLAN 531-320 PHONE: 208-343-4635 FAX: 208-343-1858 THESE DRAWINGS AND SPECIFICATIONS, AS INSTRUMENTS APPROVED: CHIEF OF FACILITY MANAGEMENT SERVICE BUILDING NUMBER DRAWN DRAWING NO. OF SERVICE, ARE AND SHALL REMAIN THE PROPERTY OF C.W. MOORE PLAZA CSH6A THE ARCHITECT / ENGINEER WHETHER THE PROJECT FOR WHICH THEY ARE MADE IS EXECUTED OR NOT. THESE AKD RJL 250 S. 5TH ST. BOISE, ID 83702 DRAWINGS AND SPECIFICATIONS SHALL NOT BE USED BY ANY PERSON OR ENTITY ON OTHER PROJECTS, FOR (208) 343-4635 FAX (208) 343-1858 APPROVED: MEDICAL CENTER DIRECTOR ADDITIONS TO THIS PROJECT, OR COMPLETION OF THIS PROJECT-WHEN PHASED-WITHOUT THE WRITTEN CONSENT OF CSHQA OR ITS AFFILIATES. Copyright ●2013 http://www.cshqa.com DWG 181 OF 191 DEPARTMENT OF VETERANS AFFAIRS



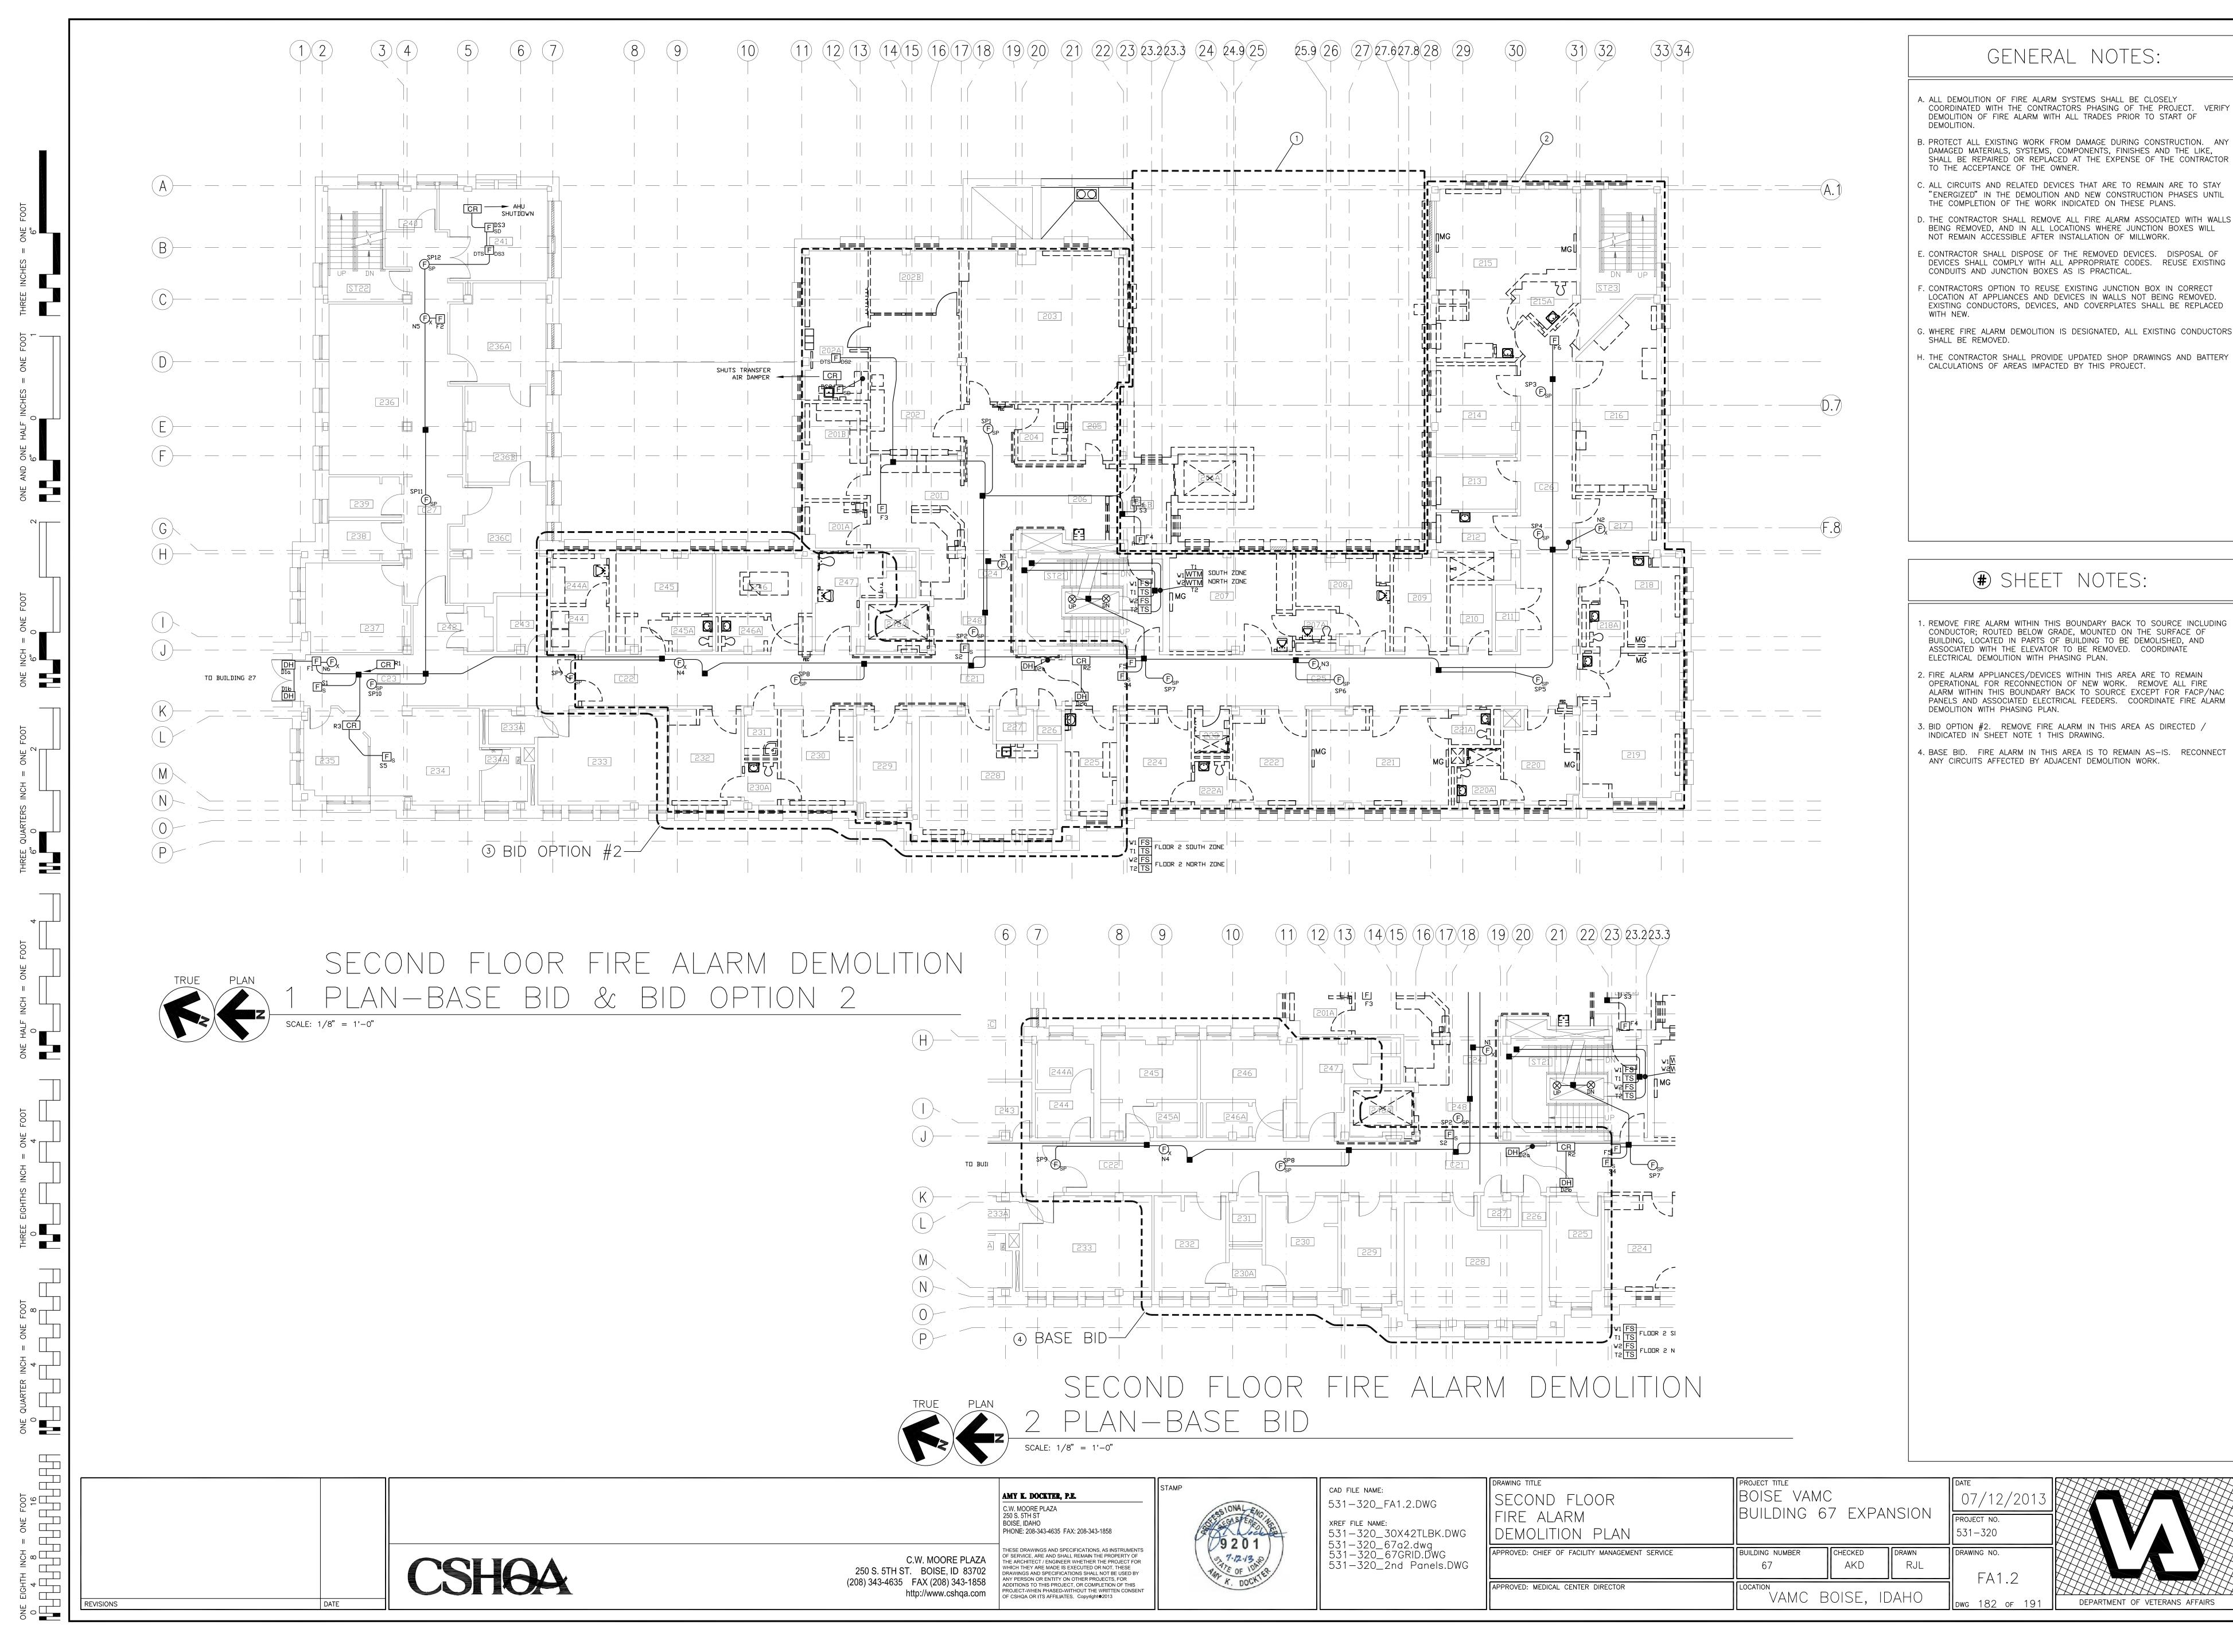

GENERAL NOTES:

- A. ALL DEMOLITION OF FIRE ALARM SYSTEMS SHALL BE CLOSELY COORDINATED WITH THE CONTRACTORS PHASING OF THE PROJECT. VERIFY DEMOLITION OF FIRE ALARM WITH ALL TRADES PRIOR TO START OF
- B. PROTECT ALL EXISTING WORK FROM DAMAGE DURING CONSTRUCTION. ANY DAMAGED MATERIALS, SYSTEMS, COMPONENTS, FINISHES AND THE LIKE, SHALL BE REPAIRED OR REPLACED AT THE EXPENSE OF THE CONTRACTOR TO THE ACCEPTANCE OF THE OWNER.
 - C. ALL CIRCUITS AND RELATED DEVICES THAT ARE TO REMAIN ARE TO STAY "ENERGIZED" IN THE DEMOLITION AND NEW CONSTRUCTION PHASES UNTIL THE COMPLETION OF THE WORK INDICATED ON THESE PLANS.
 - D. THE CONTRACTOR SHALL REMOVE ALL FIRE ALARM ASSOCIATED WITH WALLS BEING REMOVED, AND IN ALL LOCATIONS WHERE JUNCTION BOXES WILL NOT REMAIN ACCESSIBLE AFTER INSTALLATION OF MILLWORK.
- . CONTRACTOR SHALL DISPOSE OF THE REMOVED DEVICES. DISPOSAL OF DEVICES SHALL COMPLY WITH ALL APPROPRIATE CODES. REUSE EXISTING CONDUITS AND JUNCTION BOXES AS IS PRACTICAL.
- T. CONTRACTORS OPTION TO REUSE EXISTING JUNCTION BOX IN CORRECT LOCATION AT APPLIANCES AND DEVICES IN WALLS NOT BEING REMOVED. EXISTING CONDUCTORS, DEVICES, AND COVERPLATES SHALL BE REPLACED
- G. WHERE FIRE ALARM DEMOLITION IS DESIGNATED, ALL EXISTING CONDUCTORS SHALL BE REMOVED.
- H. THE CONTRACTOR SHALL PROVIDE UPDATED SHOP DRAWINGS AND BATTERY CALCULATIONS OF AREAS IMPACTED BY THIS PROJECT.

SHEET NOTES:

- REMOVE FIRE ALARM WITHIN THIS BOUNDARY BACK TO SOURCE INCLUDING CONDUCTORS; ROUTED BELOW GRADE, MOUNTED ON THE SURFACE OF BUILDING, LOCATED IN PARTS OF BUILDING TO BE DEMOLISHED, AND ASSOCIATED WITH THE ELEVATOR TO BE REMOVED. COORDINATE FIRE ALARM DEMOLITION WITH PHASING PLAN.
- 2. FIRE ALARM PANELS WITHIN THIS AREA ARE TO REMAIN OPERATIONAL FOR RECONNECTION OF NEW WORK. REMOVE ALL FIRE ALARM WITHIN THIS
- INDICATED IN SHEET NOTE 1 THIS DRAWING.

AMY K. DOCKTER, P.E. C.W. MOORE PLAZA 250 S. 5TH ST BOISE, IDAHO PHONE: 208-343-4635 FAX: 208-343-1858 THESE DRAWINGS AND SPECIFICATIONS, AS INSTRUMENTS OF SERVICE, ARE AND SHALL REMAIN THE PROPERTY OF C.W. MOORE PLAZA THE ARCHITECT / ENGINEER WHETHER THE PROJECT FOR WHICH THEY ARE MADE IS EXECUTED OR NOT. THESE 250 S. 5TH ST. BOISE, ID 83702 DRAWINGS AND SPECIFICATIONS SHALL NOT BE USED BY ANY PERSON OR ENTITY ON OTHER PROJECTS, FOR (208) 343-4635 FAX (208) 343-1858 ADDITIONS TO THIS PROJECT, OR COMPLETION OF THIS PROJECT-WHEN PHASED-WITHOUT THE WRITTEN CONSENT OF CSHQA OR ITS AFFILIATES. Copyright ●2013

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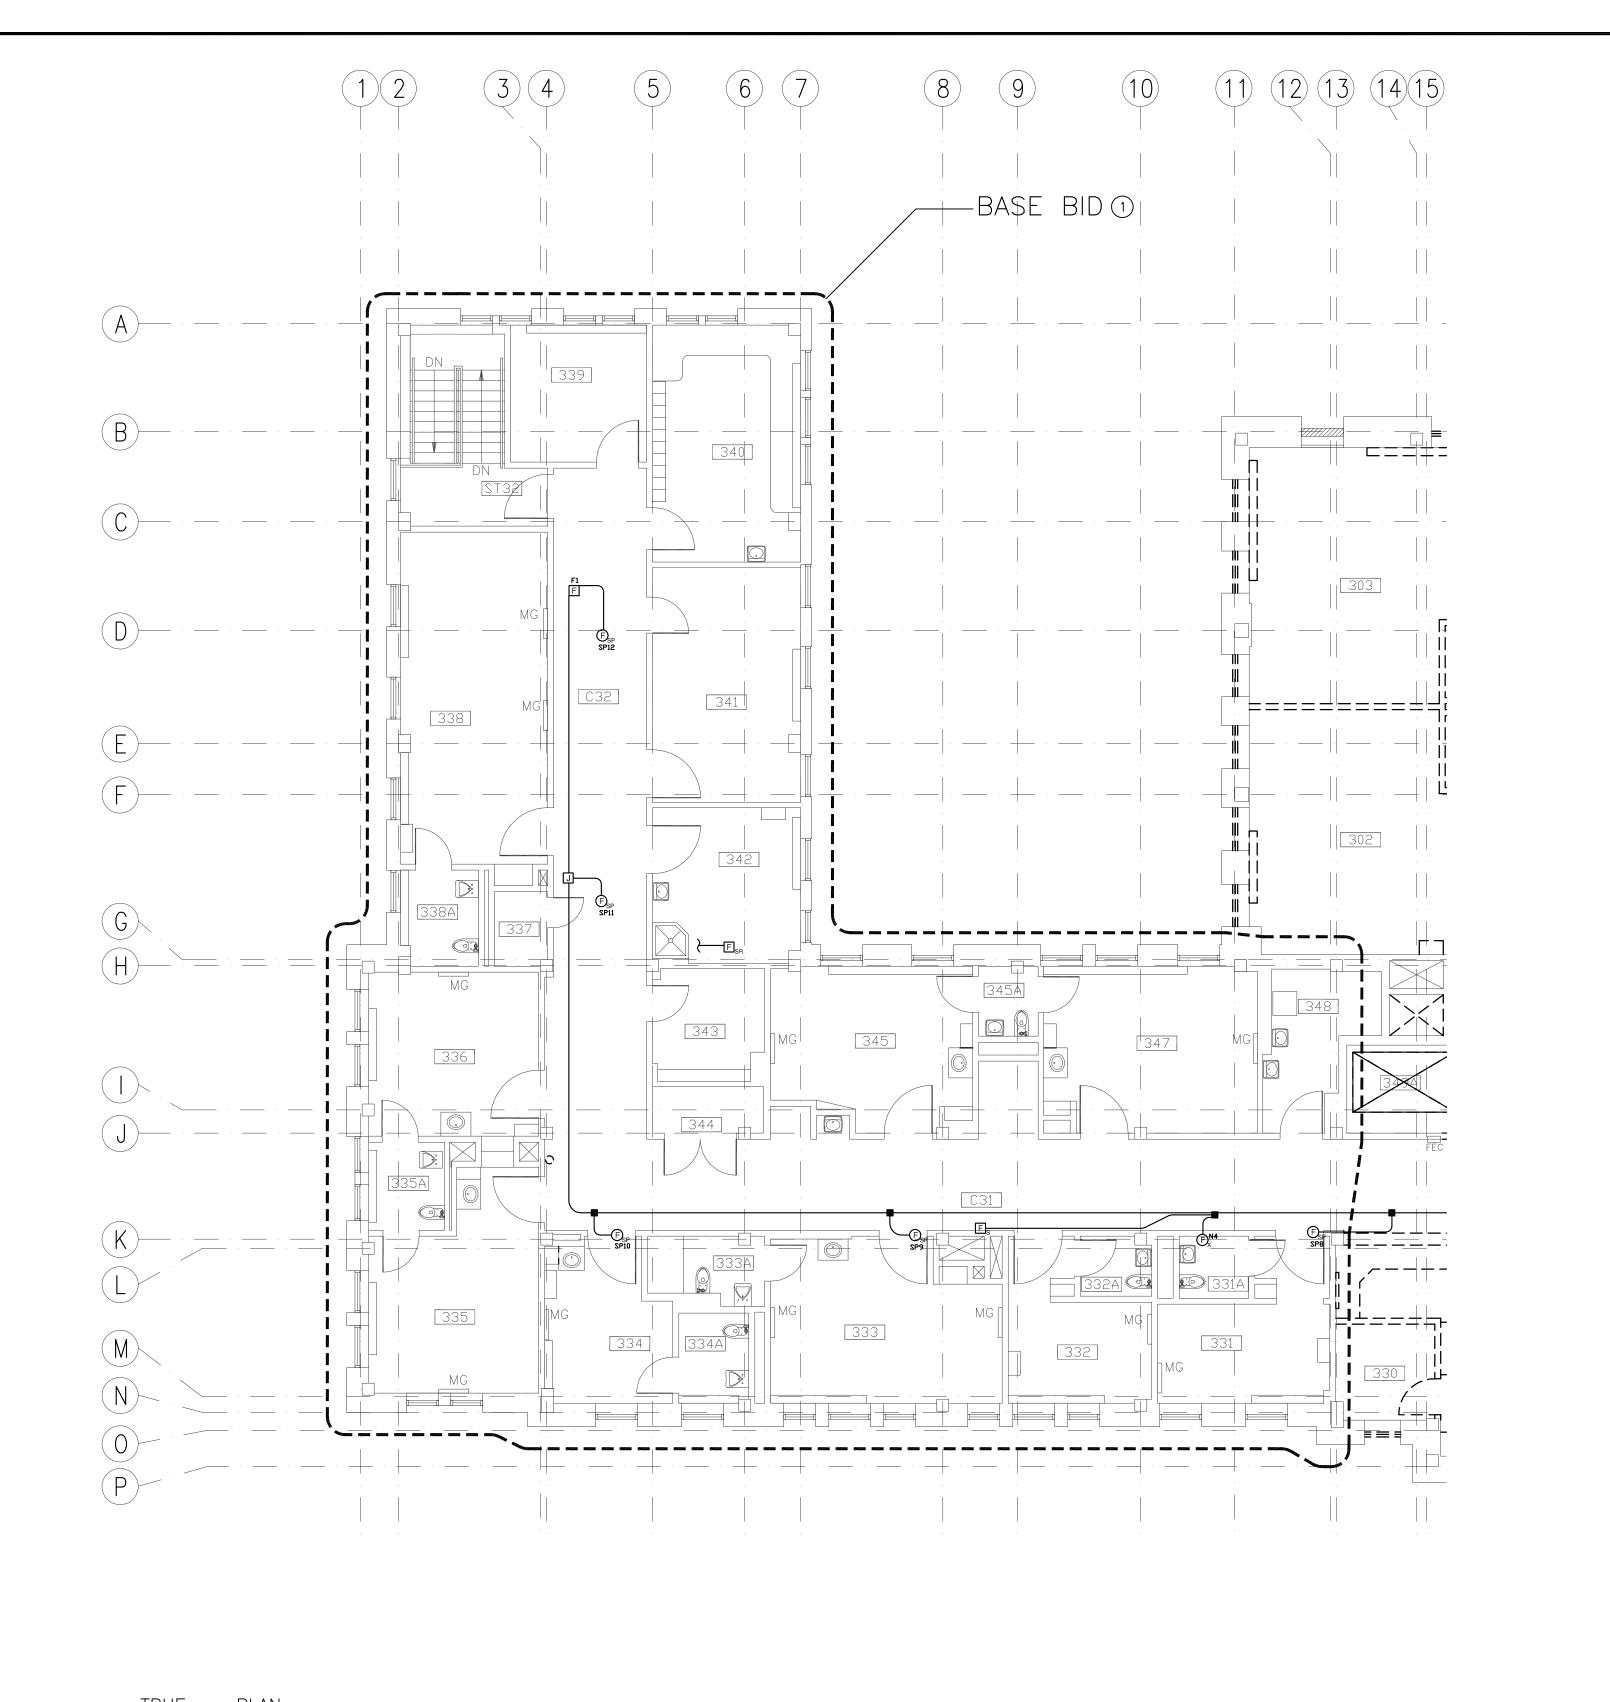
APPROVED: MEDICAL CENTER DIRECTOR

BOISE VAMC THIRD FLOOR BUILDING 67 EXPANSION FIRE ALARM DEMOLITION PLAN APPROVED: CHIEF OF FACILITY MANAGEMENT SERVICE BUILDING NUMBER DRAWN AKD RJL

531-320 DRAWING NO.

DWG 183 OF 191





GENERAL NOTES:


- A. ALL DEMOLITION OF FIRE ALARM SYSTEMS SHALL BE CLOSELY COORDINATED WITH THE CONTRACTORS PHASING OF THE PROJECT. VERIFY DEMOLITION OF FIRE ALARM WITH ALL TRADES PRIOR TO START OF
- B. PROTECT ALL EXISTING WORK FROM DAMAGE DURING CONSTRUCTION. ANY DAMAGED MATERIALS, SYSTEMS, COMPONENTS, FINISHES AND THE LIKE, SHALL BE REPAIRED OR REPLACED AT THE EXPENSE OF THE CONTRACTOR

TO THE ACCEPTANCE OF THE OWNER.

- C. ALL CIRCUITS AND RELATED DEVICES THAT ARE TO REMAIN ARE TO STAY "ENERGIZED" IN THE DEMOLITION AND NEW CONSTRUCTION PHASES UNTIL THE COMPLETION OF THE WORK INDICATED ON THESE PLANS.
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- F. CONTRACTORS OPTION TO REUSE EXISTING JUNCTION BOX IN CORRECT LOCATION AT APPLIANCES AND DEVICES IN WALLS NOT BEING REMOVED. EXISTING CONDUCTORS, DEVICES, AND COVERPLATES SHALL BE REPLACED WITH NEW.
- G. WHERE FIRE ALARM DEMOLITION IS DESIGNATED, ALL EXISTING CONDUCTORS SHALL BE REMOVED.
- H. THE CONTRACTOR SHALL PROVIDE UPDATED SHOP DRAWINGS AND BATTERY CALCULATIONS OF AREAS IMPACTED BY THIS PROJECT.

SHEET NOTES:

1. BASE BID. FIRE ALARM IN THIS AREA IS TO REMAIN AS-IS. RECONNECT ANY CIRCUITS AFFECTED BY ADJACENT DEMOLITION WORK.

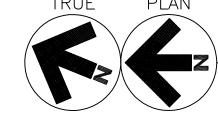

1 THIRD FLOOR FIRE ALARM DEMOLITION PLAN-BASE BID

scale: 1/8" = 1'-0"

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THIRD FLOOR FIRE ALARM DEMOLITION PLAN-BASE BID APPROVED: CHIEF OF FACILITY MANAGEMENT SERVICE

BOISE VAMC BUILDING 67 EXPANSION BUILDING NUMBER

531-320 DRAWING NO.

DEPARTMENT OF VETERANS AFFAIRS

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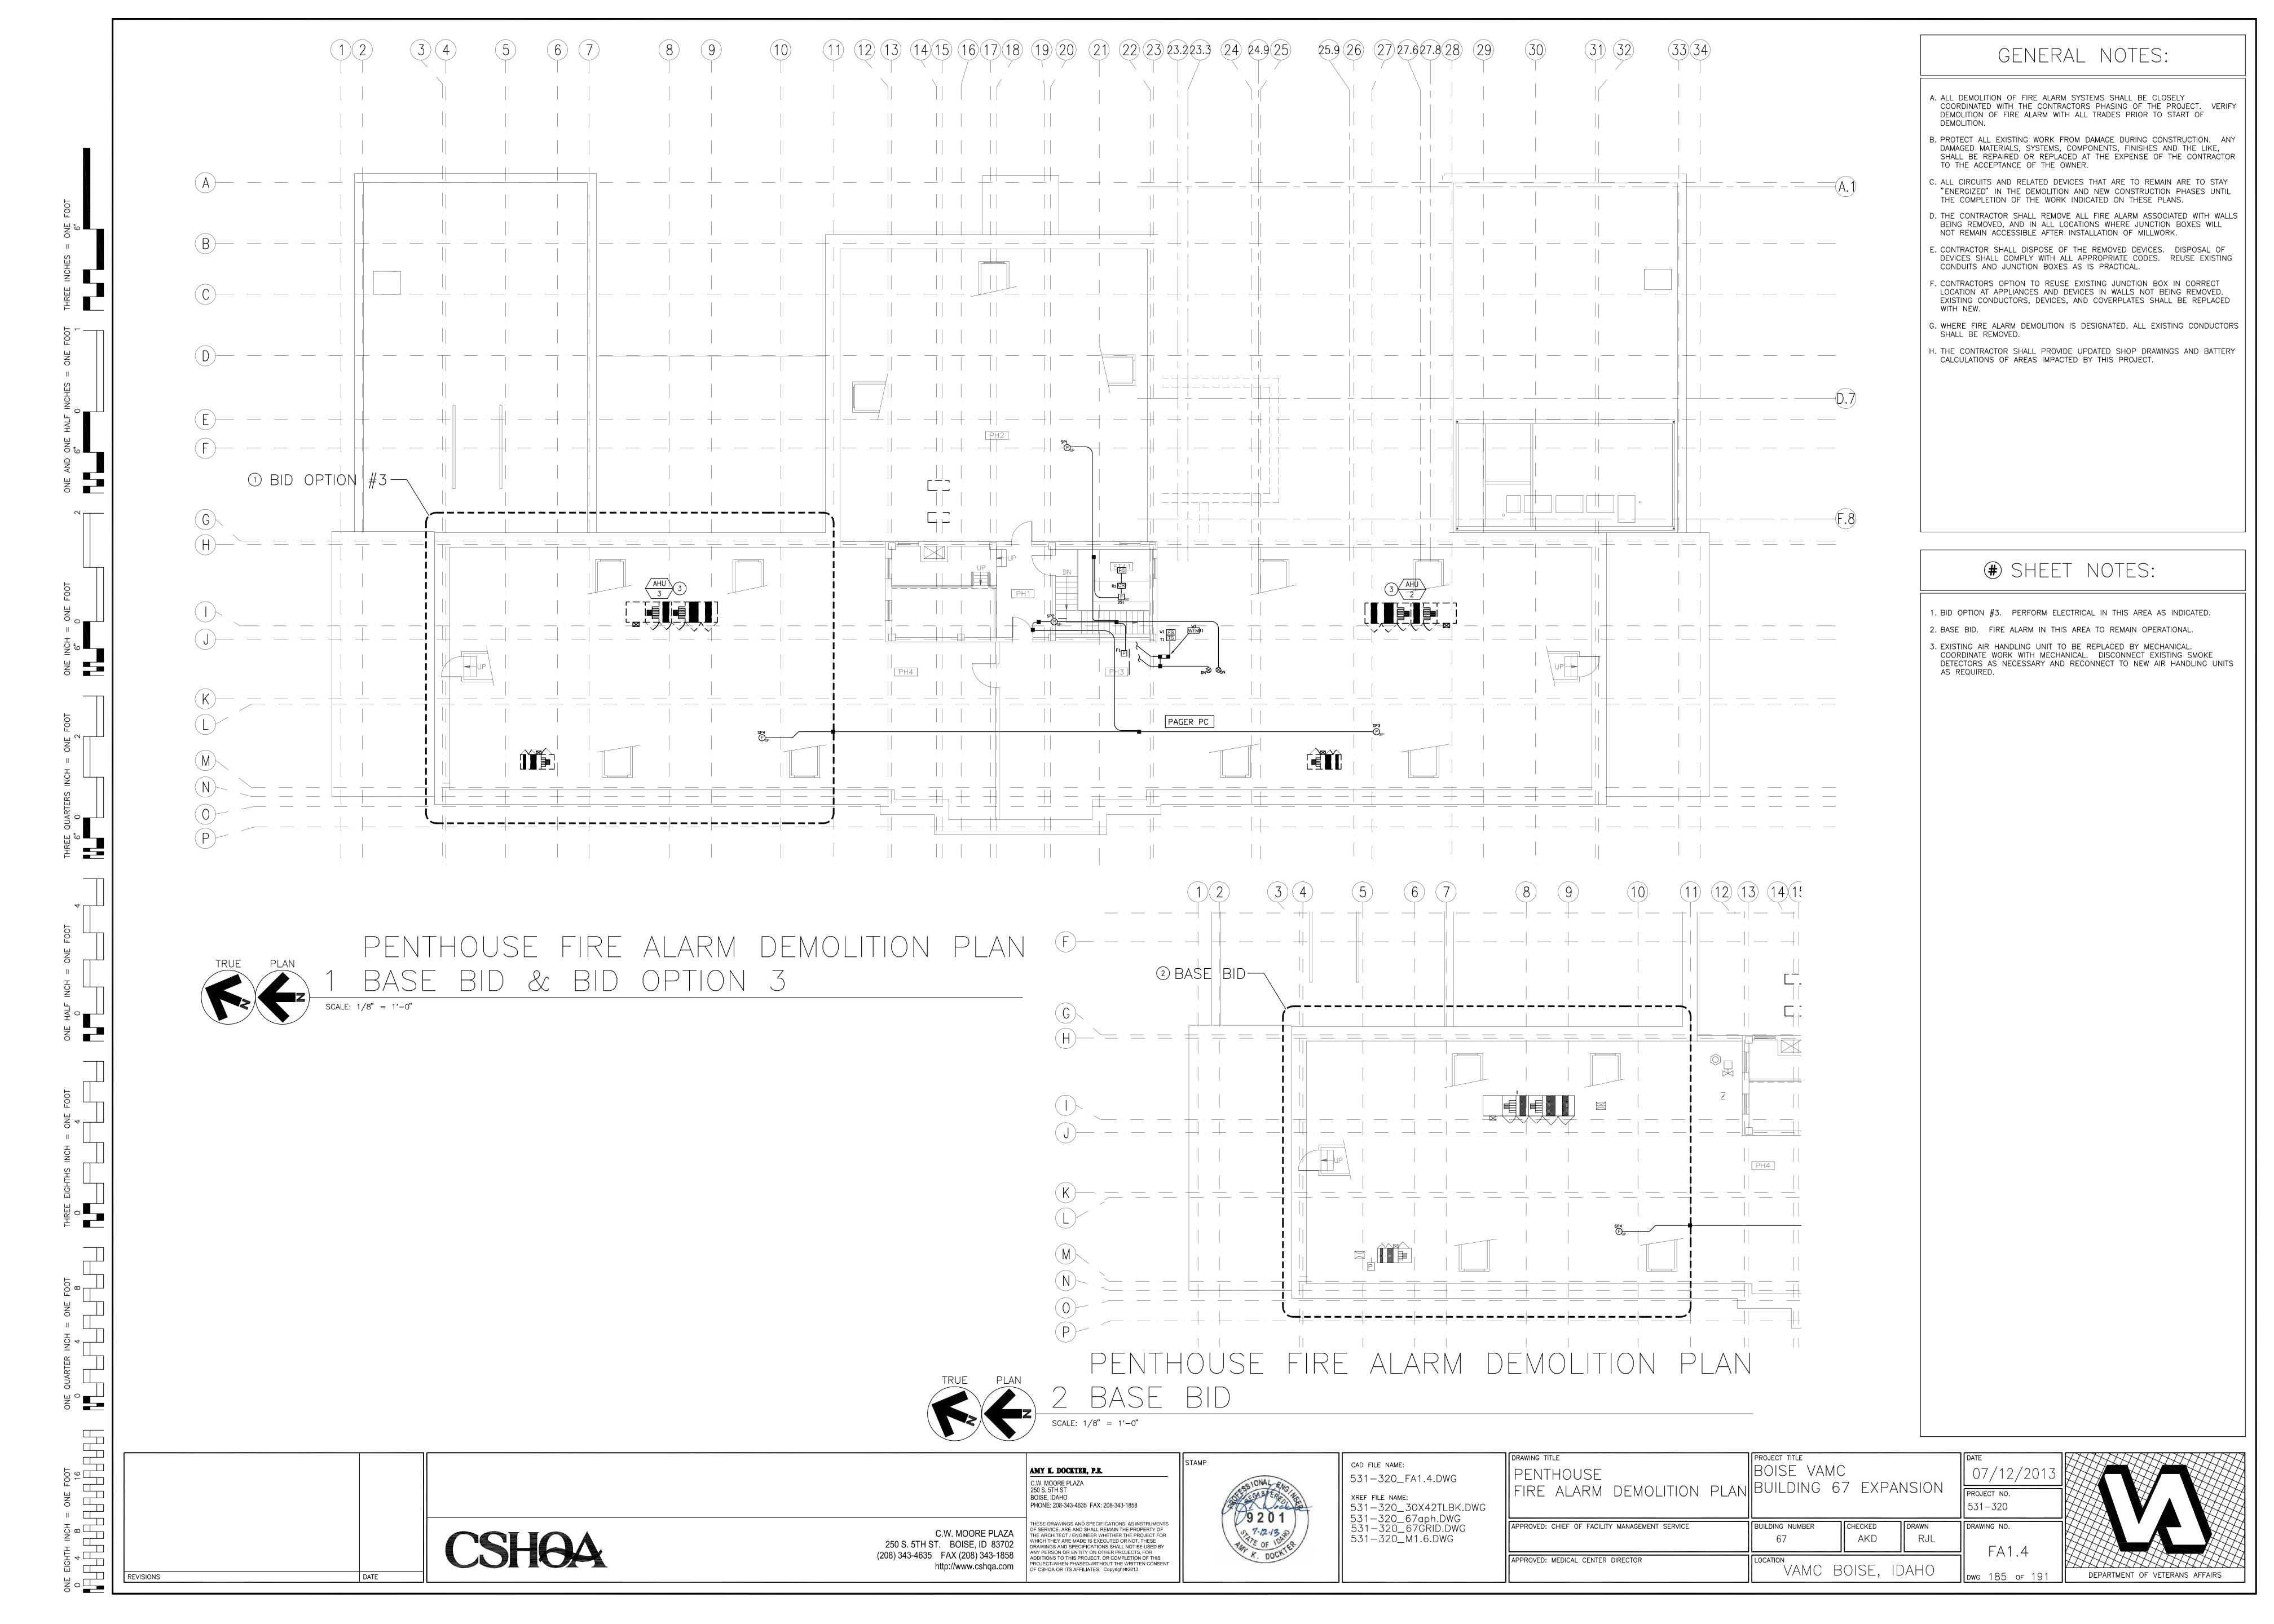
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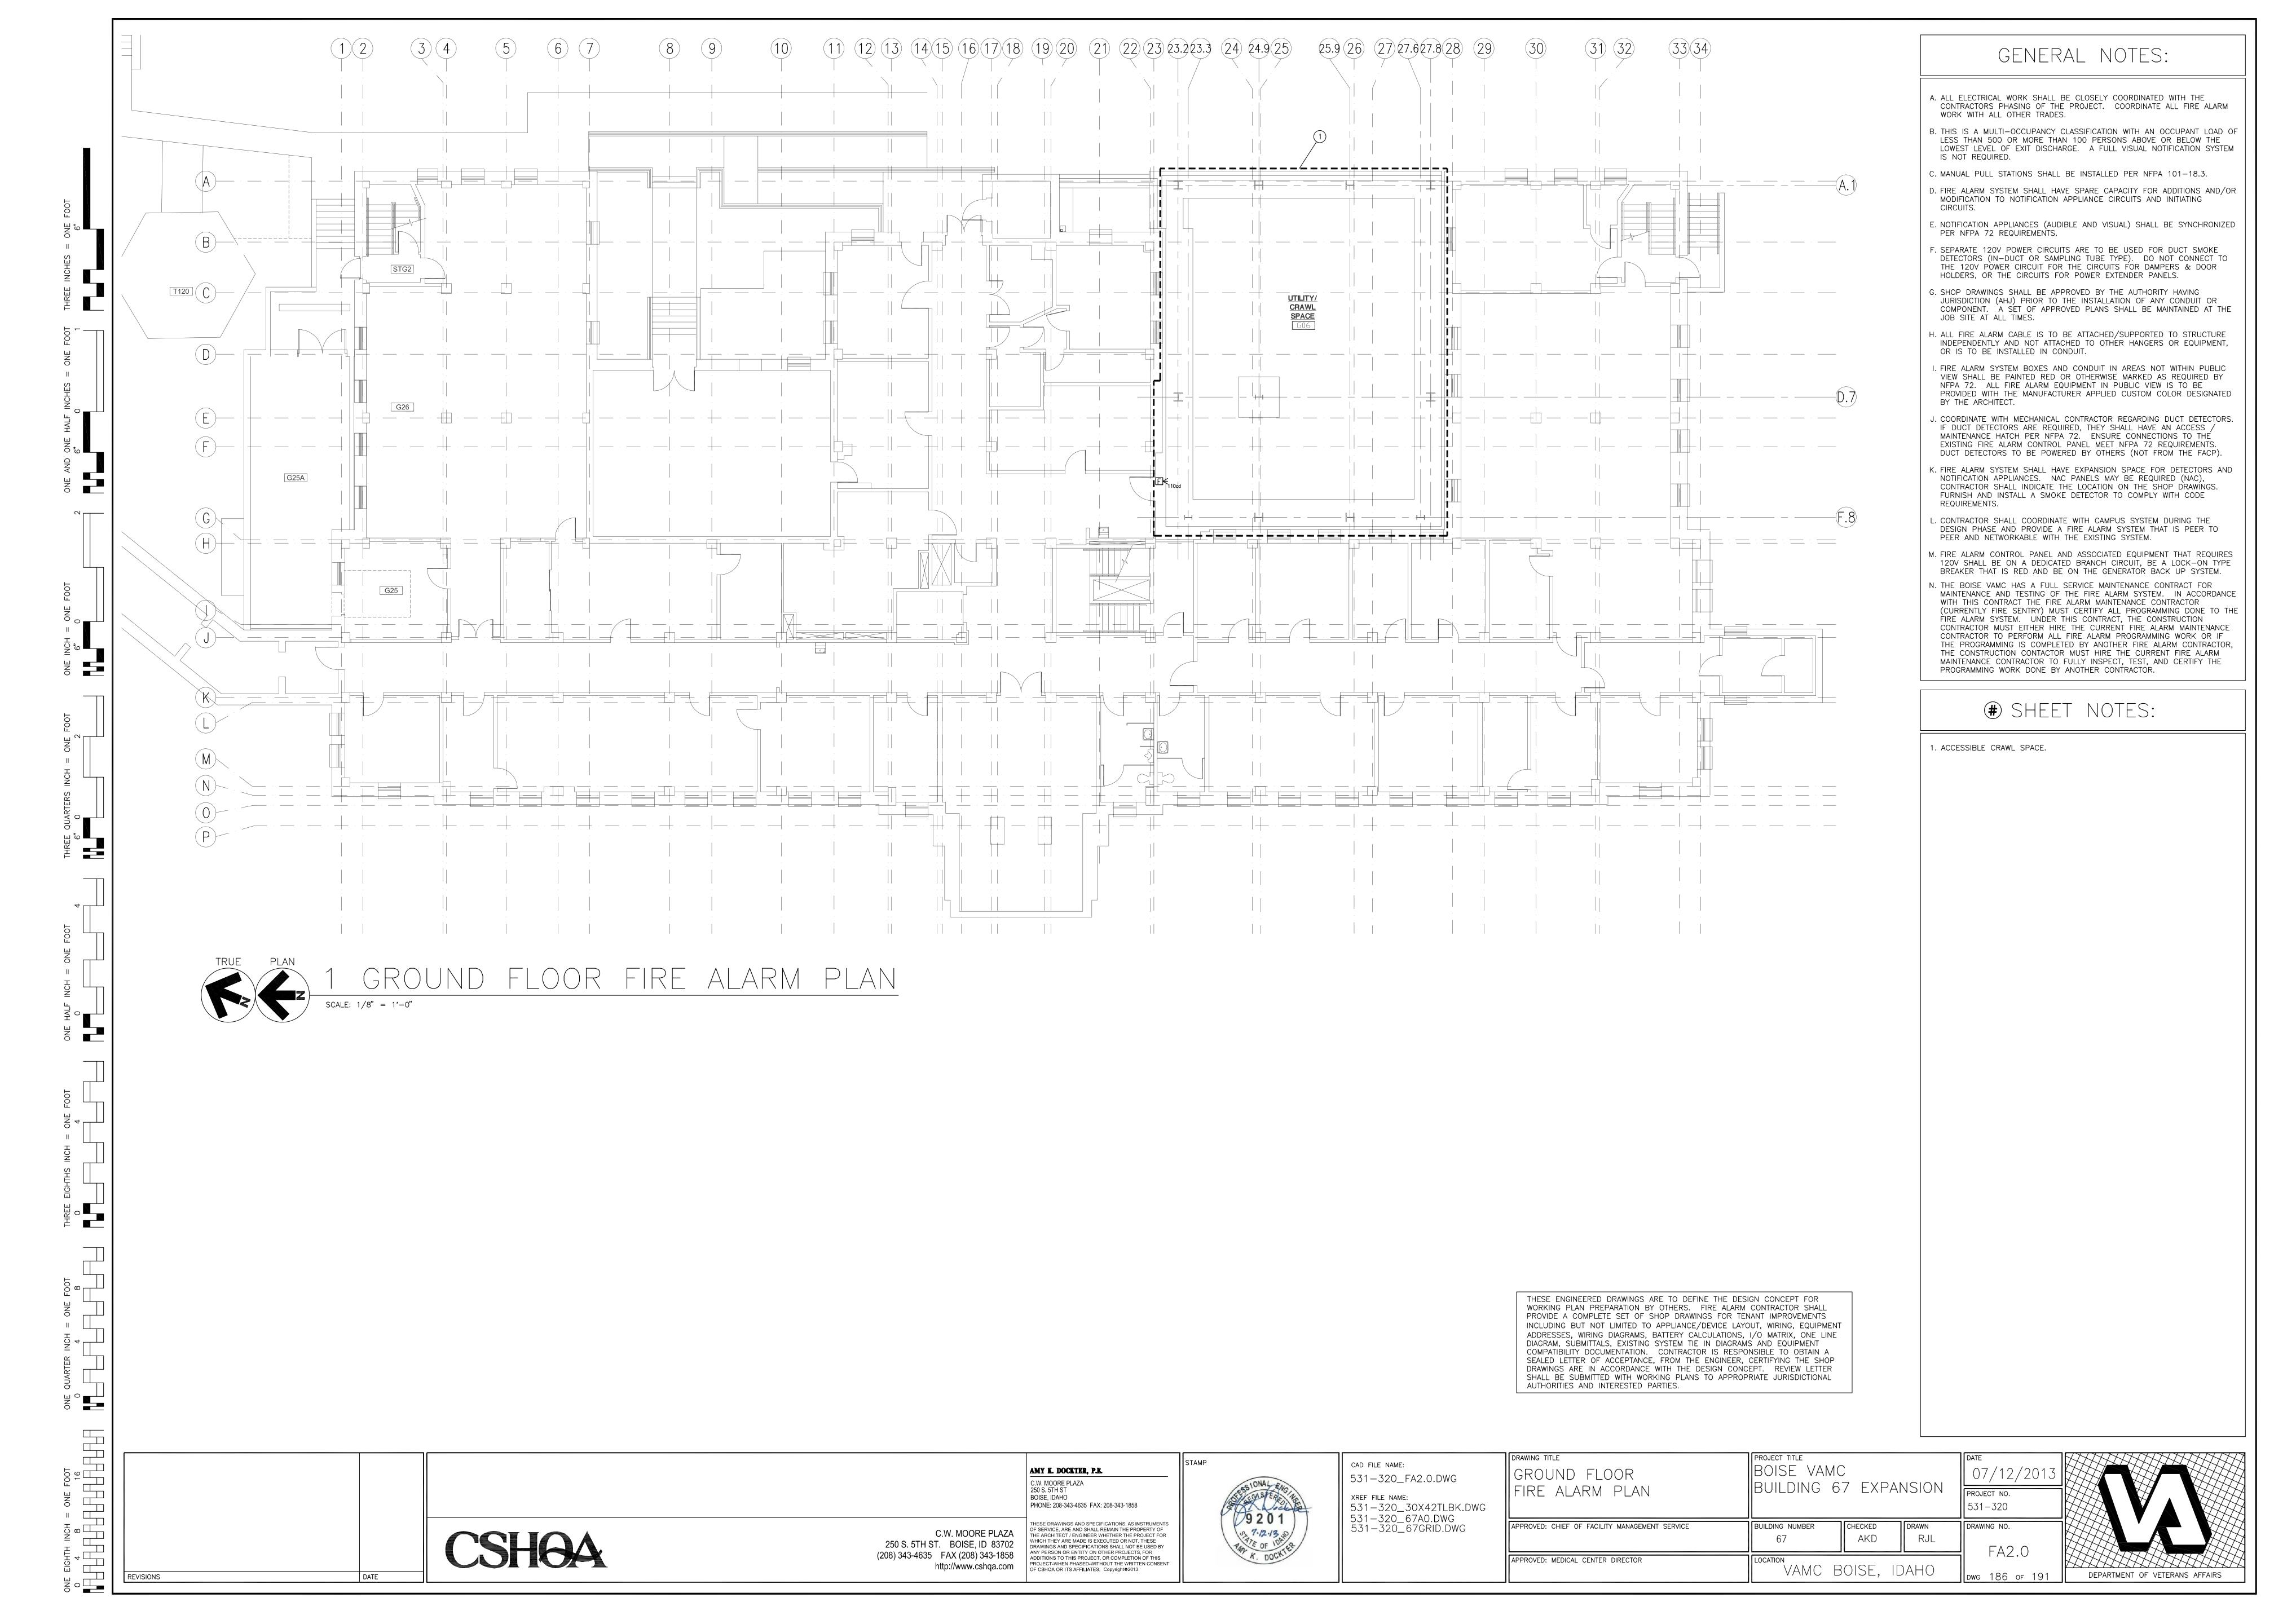
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GENERAL NOTES:

A. ALL ELECTRICAL WORK SHALL BE CLOSELY COORDINATED WITH THE CONTRACTORS PHASING OF THE PROJECT. COORDINATE ALL FIRE ALARM

WORK WITH ALL OTHER TRADES.

B. THIS IS A MULTI-OCCUPANCY CLASSIFICATION WITH AN OCCUPANT LOAD OF LESS THAN 500 OR MORE THAN 100 PERSONS ABOVE OR BELOW THE LOWEST LEVEL OF EXIT DISCHARGE. A FULL VISUAL NOTIFICATION SYSTEM IS NOT REQUIRED.

C. MANUAL PULL STATIONS SHALL BE INSTALLED PER NFPA 101-18.3. D. FIRE ALARM SYSTEM SHALL HAVE SPARE CAPACITY FOR ADDITIONS AND/OR MODIFICATION TO NOTIFICATION APPLIANCE CIRCUITS AND INITIATING

E. NOTIFICATION APPLIANCES (AUDIBLE AND VISUAL) SHALL BE SYNCHRONIZED PER NFPA 72 REQUIREMENTS.

SEPARATE 120V POWER CIRCUITS ARE TO BE USED FOR DUCT SMOKE DETECTORS (IN-DUCT OR SAMPLING TUBE TYPE). DO NOT CONNECT TO THE 120V POWER CIRCUIT FOR THE CIRCUITS FOR DAMPERS & DOOR HOLDERS, OR THE CIRCUITS FOR POWER EXTENDER PANELS.

G. SHOP DRAWINGS SHALL BE APPROVED BY THE AUTHORITY HAVING JURISDICTION (AHJ) PRIOR TO THE INSTALLATION OF ANY CONDUIT OR COMPONENT. A SET OF APPROVED PLANS SHALL BE MAINTAINED AT THE JOB SITE AT ALL TIMES.

H. ALL FIRE ALARM CABLE IS TO BE ATTACHED/SUPPORTED TO STRUCTURE INDEPENDENTLY AND NOT ATTACHED TO OTHER HANGERS OR EQUIPMENT, OR IS TO BE INSTALLED IN CONDUIT.

I. FIRE ALARM SYSTEM BOXES AND CONDUIT IN AREAS NOT WITHIN PUBLIC VIEW SHALL BE PAINTED RED OR OTHERWISE MARKED AS REQUIRED BY NFPA 72. ALL FIRE ALARM EQUIPMENT IN PUBLIC VIEW IS TO BE PROVIDED WITH THE MANUFACTURER APPLIED CUSTOM COLOR DESIGNATED BY THE ARCHITECT.

IF DUCT DETECTORS ARE REQUIRED, THEY SHALL HAVE AN ACCESS / MAINTENANCE HATCH PER NFPA 72. ENSURE CONNECTIONS TO THE EXISTING FIRE ALARM CONTROL PANEL MEET NFPA 72 REQUIREMENTS. DUCT DETECTORS TO BE POWERED BY OTHERS (NOT FROM THE FACP)

K. FIRE ALARM SYSTEM SHALL HAVE EXPANSION SPACE FOR DETECTORS AND NOTIFICATION APPLIANCES. NAC PANELS MAY BE REQUIRED (NAC), CONTRACTOR SHALL INDICATE THE LOCATION ON THE SHOP DRAWINGS. FURNISH AND INSTALL A SMOKE DETECTOR TO COMPLY WITH CODE REQUIREMENTS.


. CONTRACTOR SHALL COORDINATE WITH CAMPUS SYSTEM DURING THE DESIGN PHASE AND PROVIDE A FIRE ALARM SYSTEM THAT IS PEER TO PEER AND NETWORKABLE WITH THE EXISTING SYSTEM.

M. FIRE ALARM CONTROL PANEL AND ASSOCIATED EQUIPMENT THAT REQUIRES 120V SHALL BE ON A DEDICATED BRANCH CIRCUIT, BE A LOCK-ON TYPE BREAKER THAT IS RED AND BE ON THE GENERATOR BACK UP SYSTEM. N. THE SAME CONTRACTOR (FIRE SENTRY) THAT PERFORMS THE INSTALLATION WILL PROVIDE THE OWNER / OWNERS REPRESENTATIVE WITH INSTRUCTION AS HOW TO MANAGE/CONTROL/AND PROGRAM THE INSTALLED FIRE ALARM

SHEET NOTES:

. SMOKE DETECTOR LOCATED IN LOBBY FOR ELEVATOR RECALL.


531-320

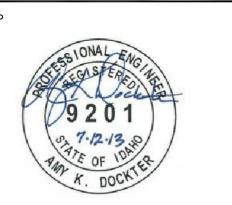

APPROVED: MEDICAL CENTER DIRECTOR "VAMC BOISE, IDAHO

DRAWING NO. DWG 187 OF 191

DEPARTMENT OF VETERANS AFFAIRS

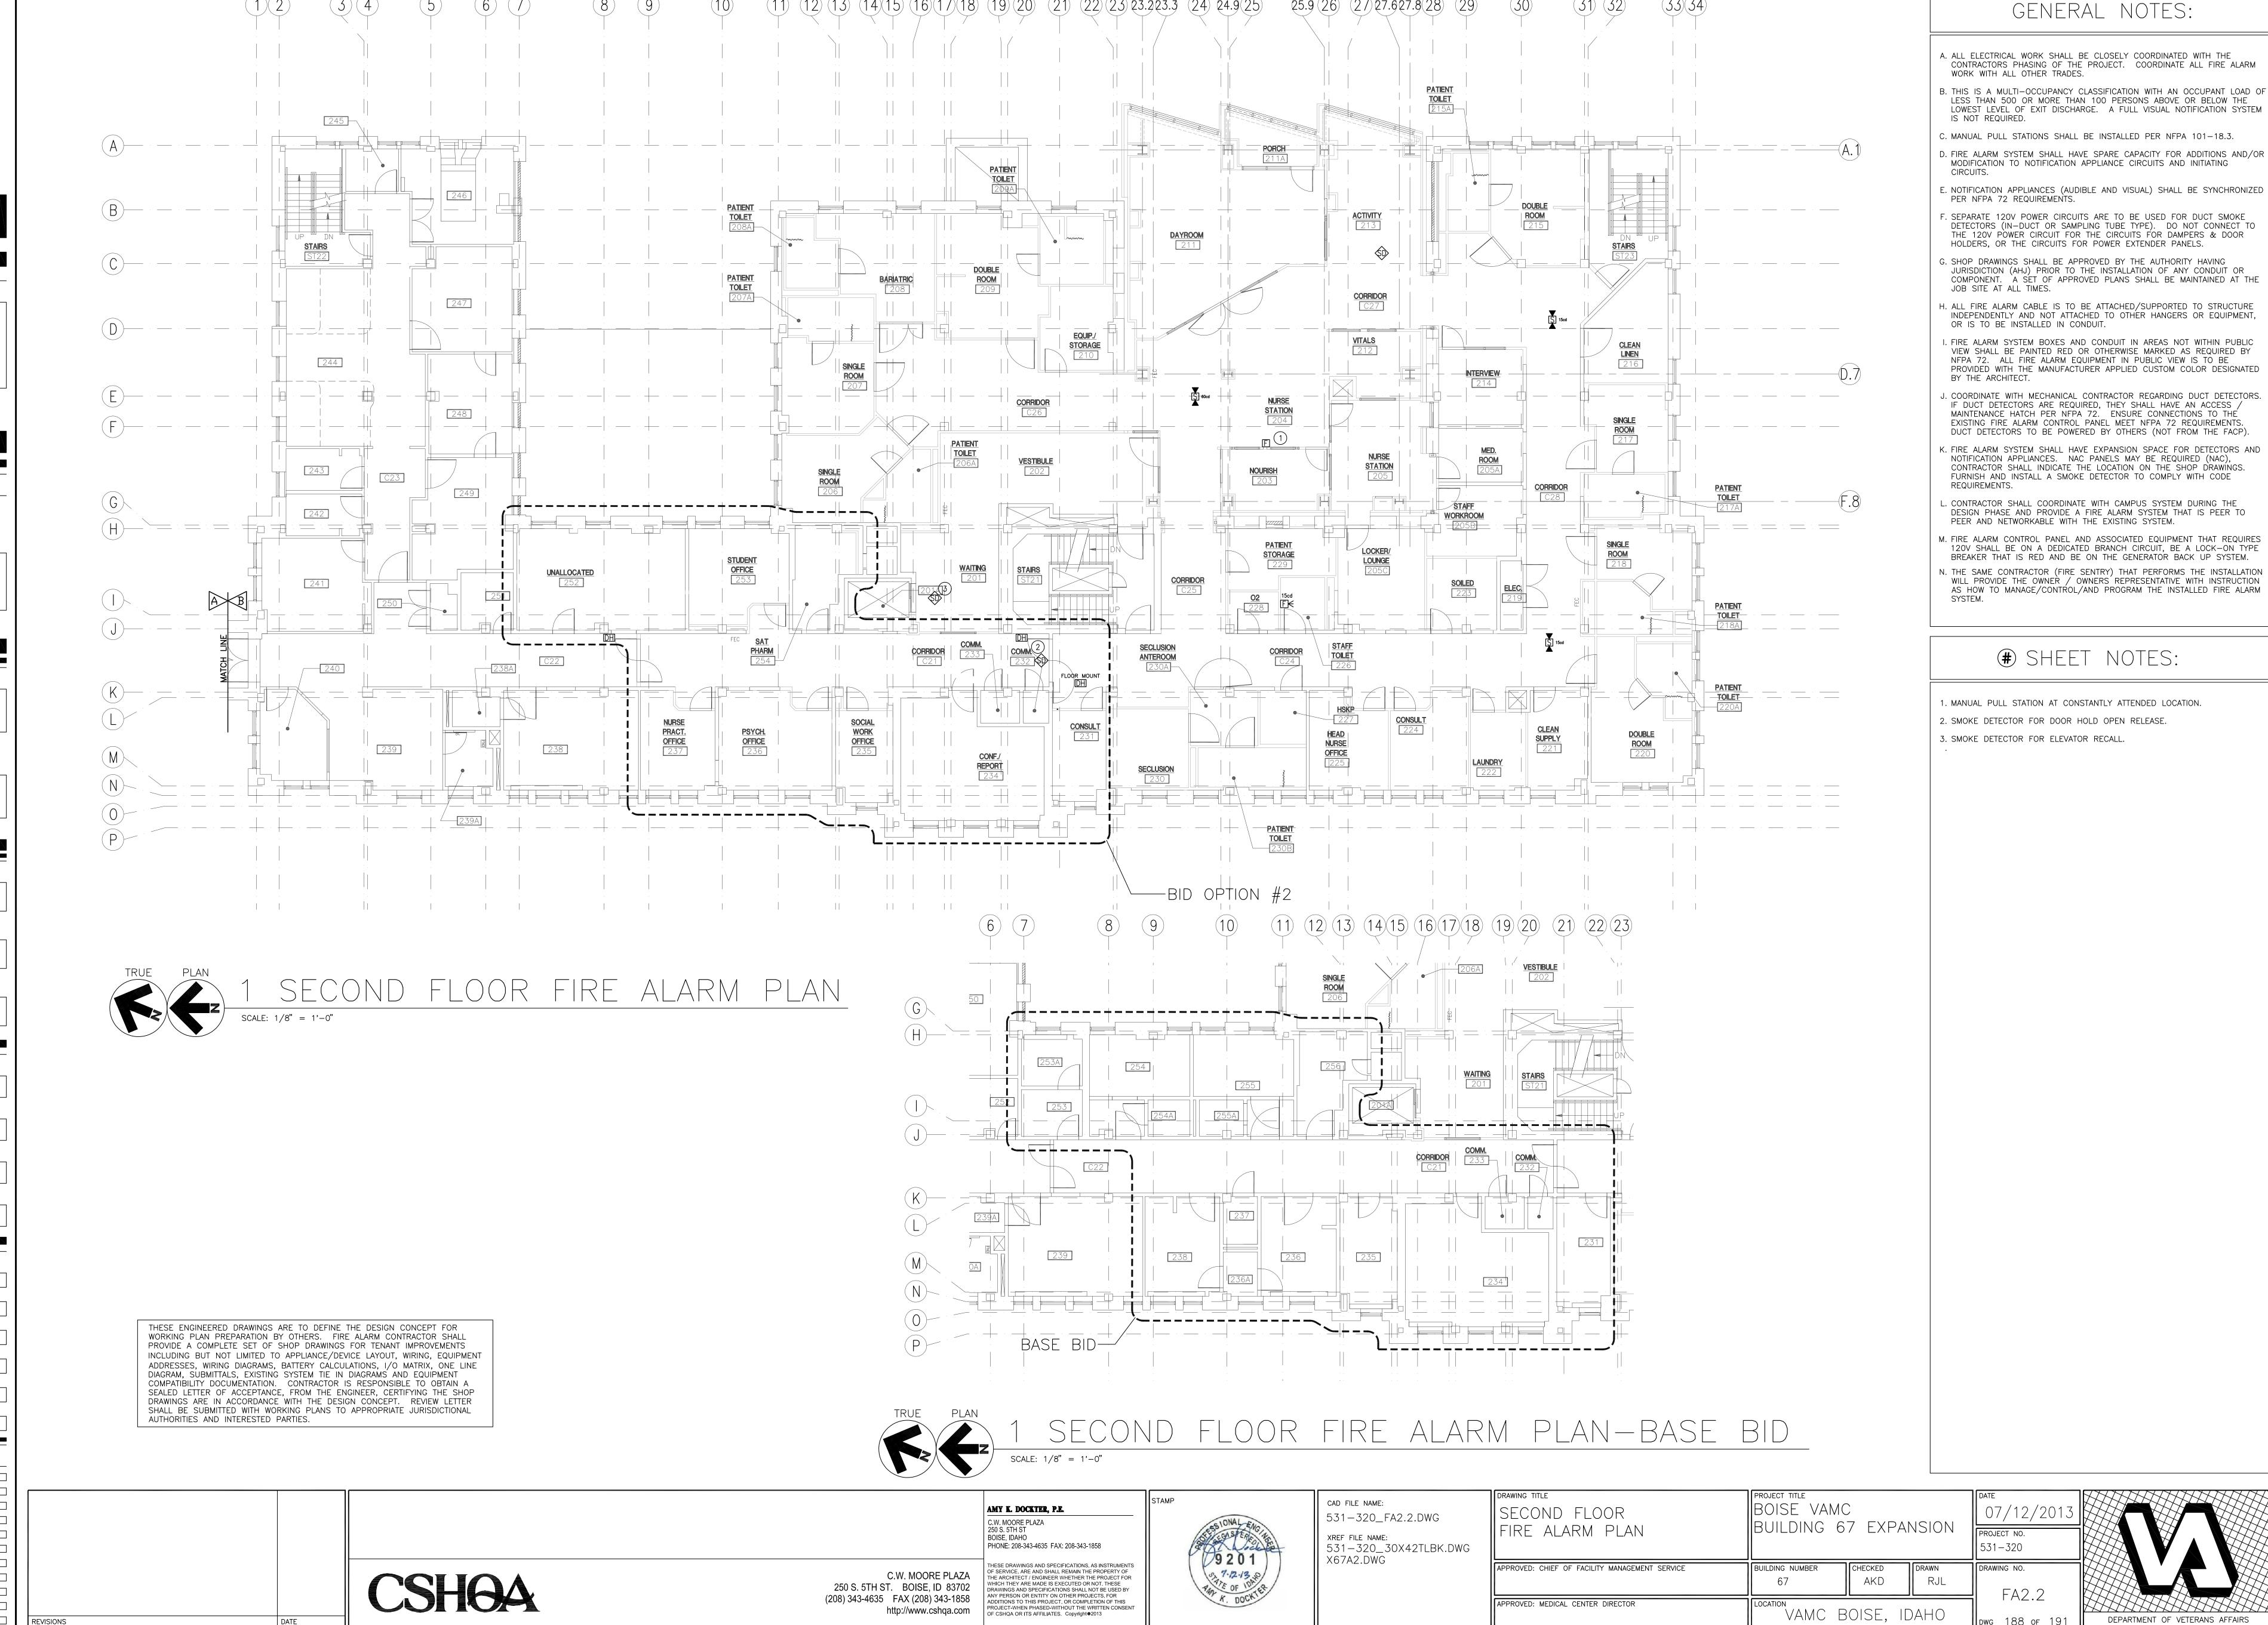

A. ALL ELECTRICAL WORK SHALL BE CLOSELY COORDINATED WITH THE CONTRACTORS PHASING OF THE PROJECT. COORDINATE ALL FIRE ALARM

B. THIS IS A MULTI-OCCUPANCY CLASSIFICATION WITH AN OCCUPANT LOAD OF LESS THAN 500 OR MORE THAN 100 PERSONS ABOVE OR BELOW THE LOWEST LEVEL OF EXIT DISCHARGE. A FULL VISUAL NOTIFICATION SYSTEM

C. MANUAL PULL STATIONS SHALL BE INSTALLED PER NFPA 101-18.3.

SEPARATE 120V POWER CIRCUITS ARE TO BE USED FOR DUCT SMOKE DETECTORS (IN-DUCT OR SAMPLING TUBE TYPE). DO NOT CONNECT TO THE 120V POWER CIRCUIT FOR THE CIRCUITS FOR DAMPERS & DOOR HOLDERS, OR THE CIRCUITS FOR POWER EXTENDER PANELS.

G. SHOP DRAWINGS SHALL BE APPROVED BY THE AUTHORITY HAVING JURISDICTION (AHJ) PRIOR TO THE INSTALLATION OF ANY CONDUIT OR COMPONENT. A SET OF APPROVED PLANS SHALL BE MAINTAINED AT THE

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I. FIRE ALARM SYSTEM BOXES AND CONDUIT IN AREAS NOT WITHIN PUBLIC VIEW SHALL BE PAINTED RED OR OTHERWISE MARKED AS REQUIRED BY NFPA 72. ALL FIRE ALARM EQUIPMENT IN PUBLIC VIEW IS TO BE PROVIDED WITH THE MANUFACTURER APPLIED CUSTOM COLOR DESIGNATED


IF DUCT DETECTORS ARE REQUIRED, THEY SHALL HAVE AN ACCESS / MAINTENANCE HATCH PER NFPA 72. ENSURE CONNECTIONS TO THE EXISTING FIRE ALARM CONTROL PANEL MEET NFPA 72 REQUIREMENTS. DUCT DETECTORS TO BE POWERED BY OTHERS (NOT FROM THE FACP)

K. FIRE ALARM SYSTEM SHALL HAVE EXPANSION SPACE FOR DETECTORS AND NOTIFICATION APPLIANCES. NAC PANELS MAY BE REQUIRED (NAC), CONTRACTOR SHALL INDICATE THE LOCATION ON THE SHOP DRAWINGS. FURNISH AND INSTALL A SMOKE DETECTOR TO COMPLY WITH CODE

DESIGN PHASE AND PROVIDE A FIRE ALARM SYSTEM THAT IS PEER TO PEER AND NETWORKABLE WITH THE EXISTING SYSTEM.

120V SHALL BE ON A DEDICATED BRANCH CIRCUIT, BE A LOCK-ON TYPE BREAKER THAT IS RED AND BE ON THE GENERATOR BACK UP SYSTEM. N. THE SAME CONTRACTOR (FIRE SENTRY) THAT PERFORMS THE INSTALLATION WILL PROVIDE THE OWNER / OWNERS REPRESENTATIVE WITH INSTRUCTION AS HOW TO MANAGE/CONTROL/AND PROGRAM THE INSTALLED FIRE ALARM

1. MANUAL PULL STATION AT CONSTANTLY ATTENDED LOCATION. 2. SMOKE DETECTOR FOR DOOR HOLD OPEN RELEASE.

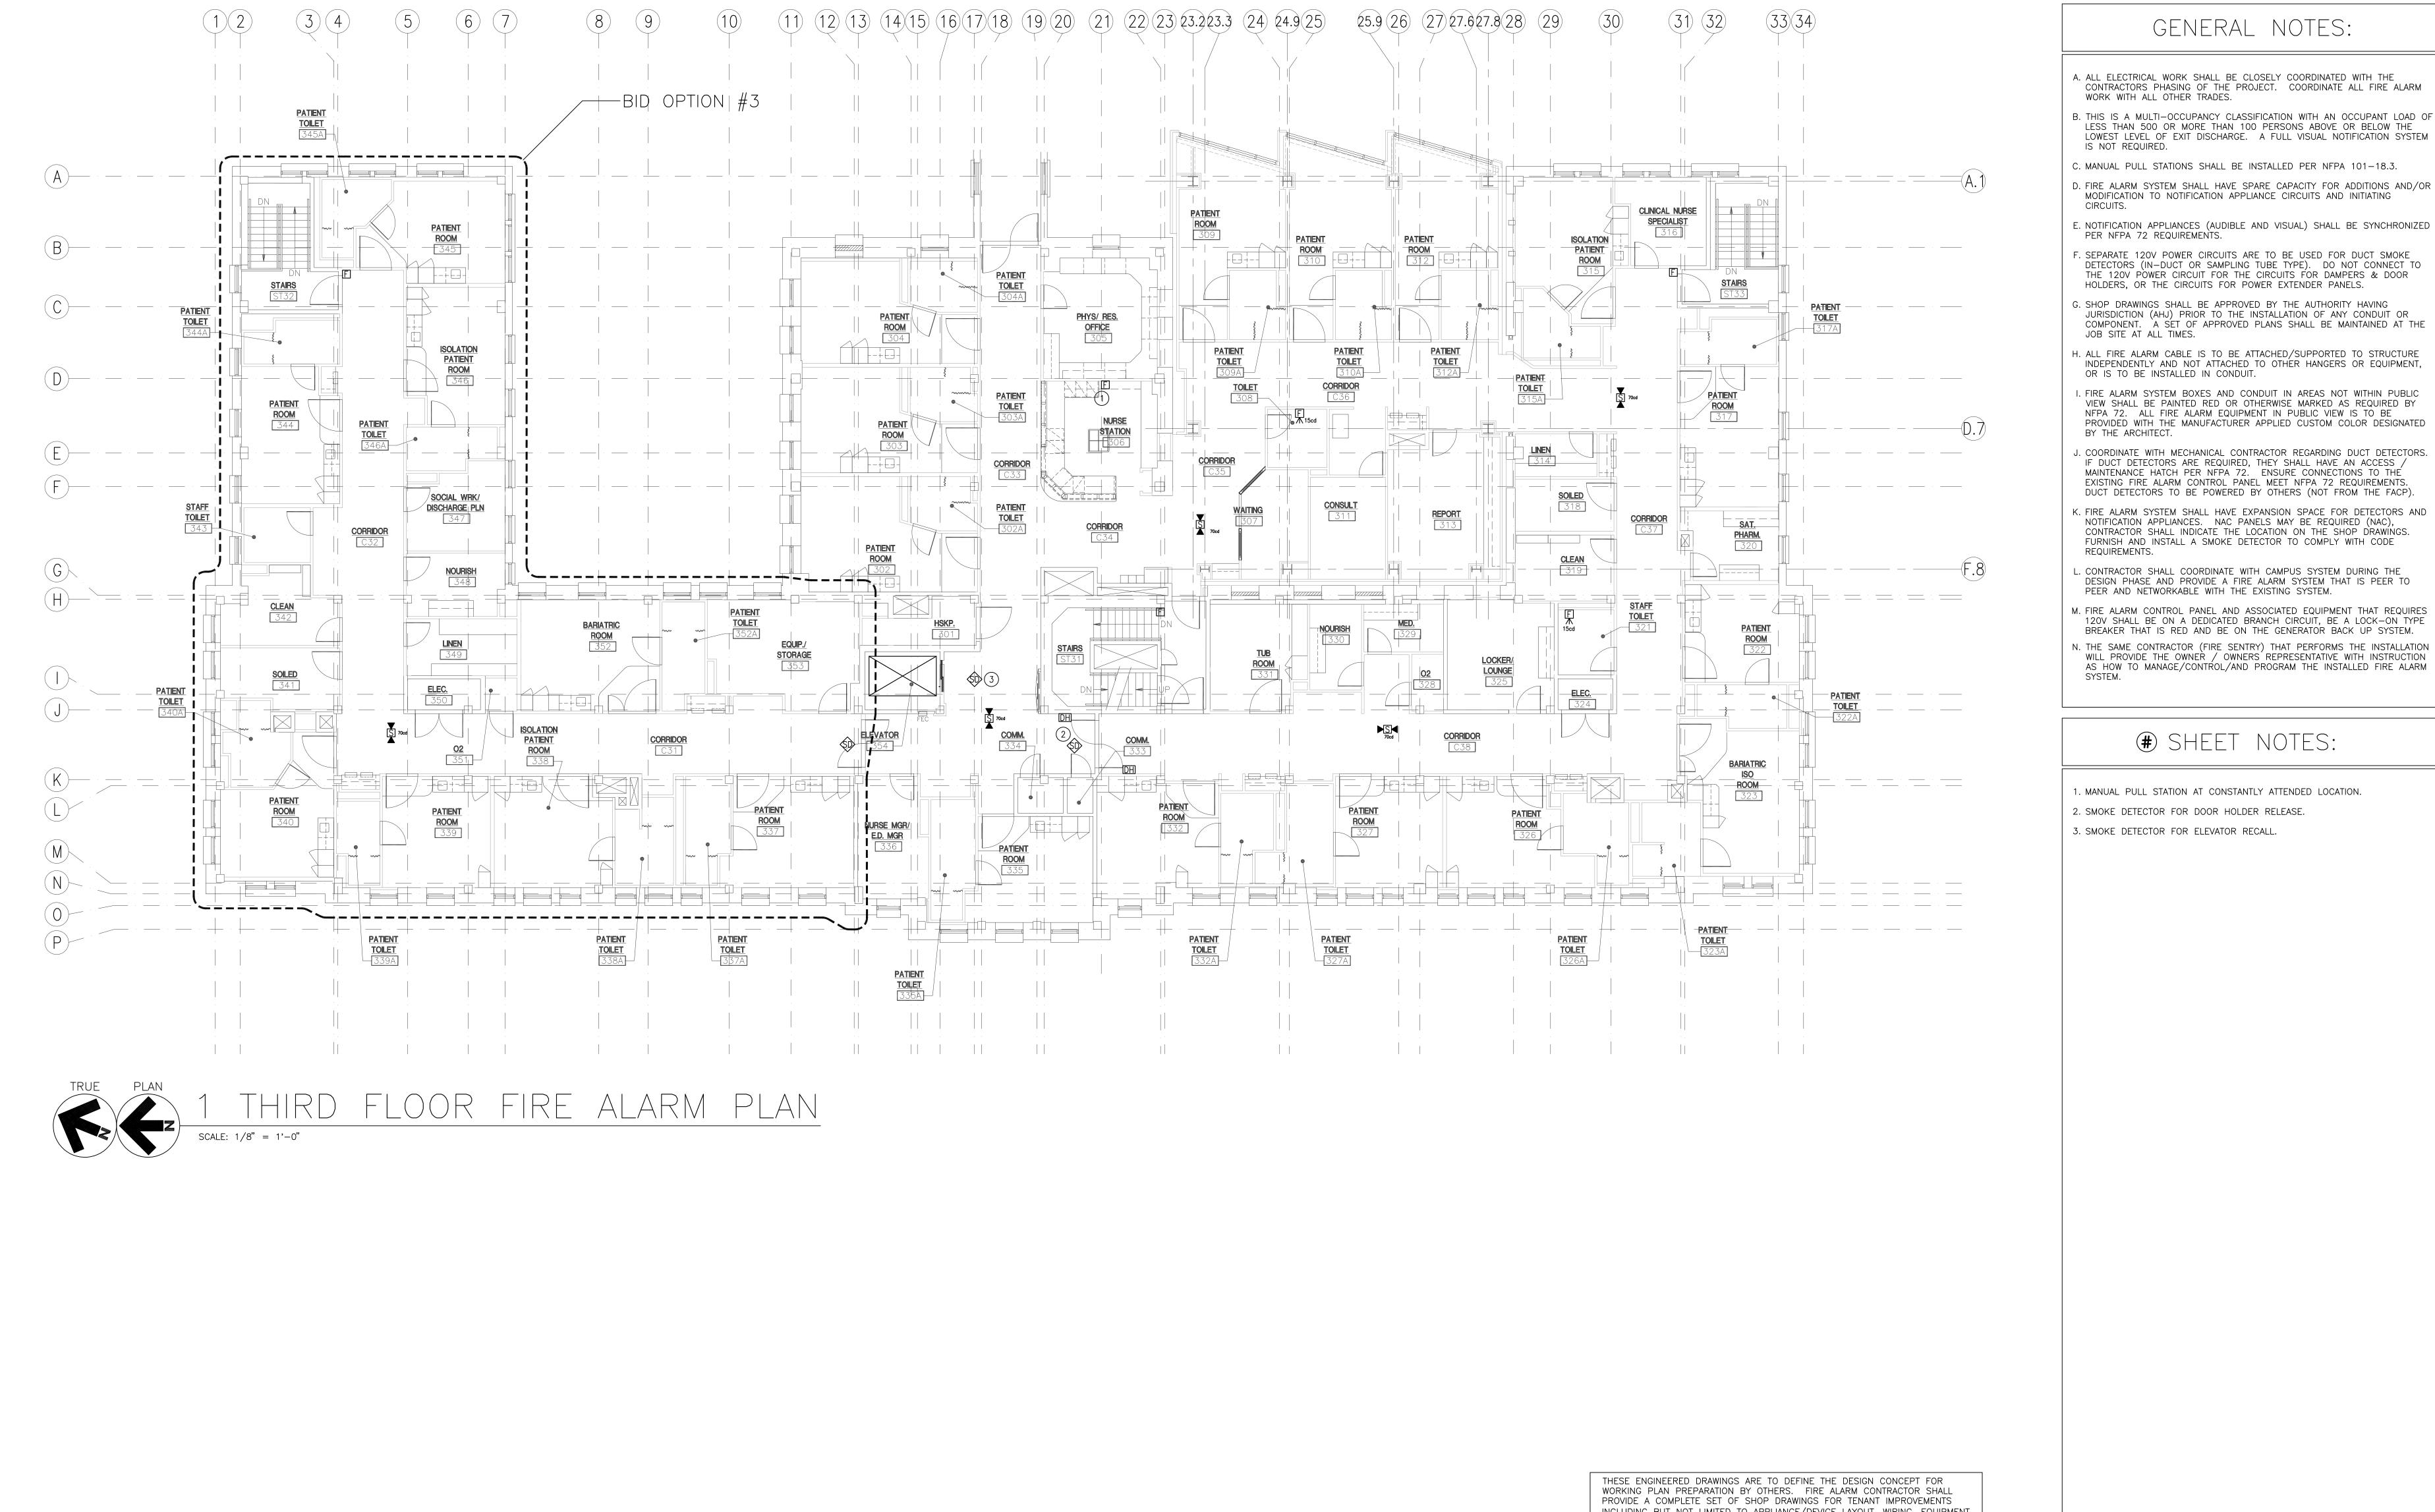

INCLUDING BUT NOT LIMITED TO APPLIANCE/DEVICE LAYOUT, WIRING, EQUIPMENT ADDRESSES, WIRING DIAGRAMS, BATTERY CALCULATIONS, I/O MATRIX, ONE LINE DIAGRAM, SUBMITTALS, EXISTING SYSTEM TIE IN DIAGRAMS AND EQUIPMENT COMPATIBILITY DOCUMENTATION. CONTRACTOR IS RESPONSIBLE TO OBTAIN A SEALED LETTER OF ACCEPTANCE, FROM THE ENGINEER, CERTIFYING THE SHOP DRAWINGS ARE IN ACCORDANCE WITH THE DESIGN CONCEPT. REVIEW LETTER SHALL BE SUBMITTED WITH WORKING PLANS TO APPROPRIATE JURISDICTIONAL AUTHORITIES AND INTERESTED PARTIES.

APPROVED: MEDICAL CENTER DIRECTOR

BOISE VAMC BUILDING 67 EXPANSION 531-320 BUILDING NUMBER DRAWN DRAWING NO. AKD RJL "VAMC BOISE, IDAHO

DWG 189 OF 191

AMY K. DOCKTER, P.E. C.W. MOORE PLAZA 250 S. 5TH ST BOISE, IDAHO PHONE: 208-343-4635 FAX: 208-343-1858 THESE DRAWINGS AND SPECIFICATIONS. AS INSTRUMENTS OF SERVICE, ARE AND SHALL REMAIN THE PROPERTY OF C.W. MOORE PLAZA THE ARCHITECT / ENGINEER WHETHER THE PROJECT FOR 250 S. 5TH ST. BOISE, ID 83702 DRAWINGS AND SPECIFICATIONS SHALL NOT BE USED BY ANY PERSON OR ENTITY ON OTHER PROJECTS, FOR (208) 343-4635 FAX (208) 343-1858 ADDITIONS TO THIS PROJECT, OR COMPLETION OF THIS PROJECT-WHEN PHASED-WITHOUT THE WRITTEN CONSENT

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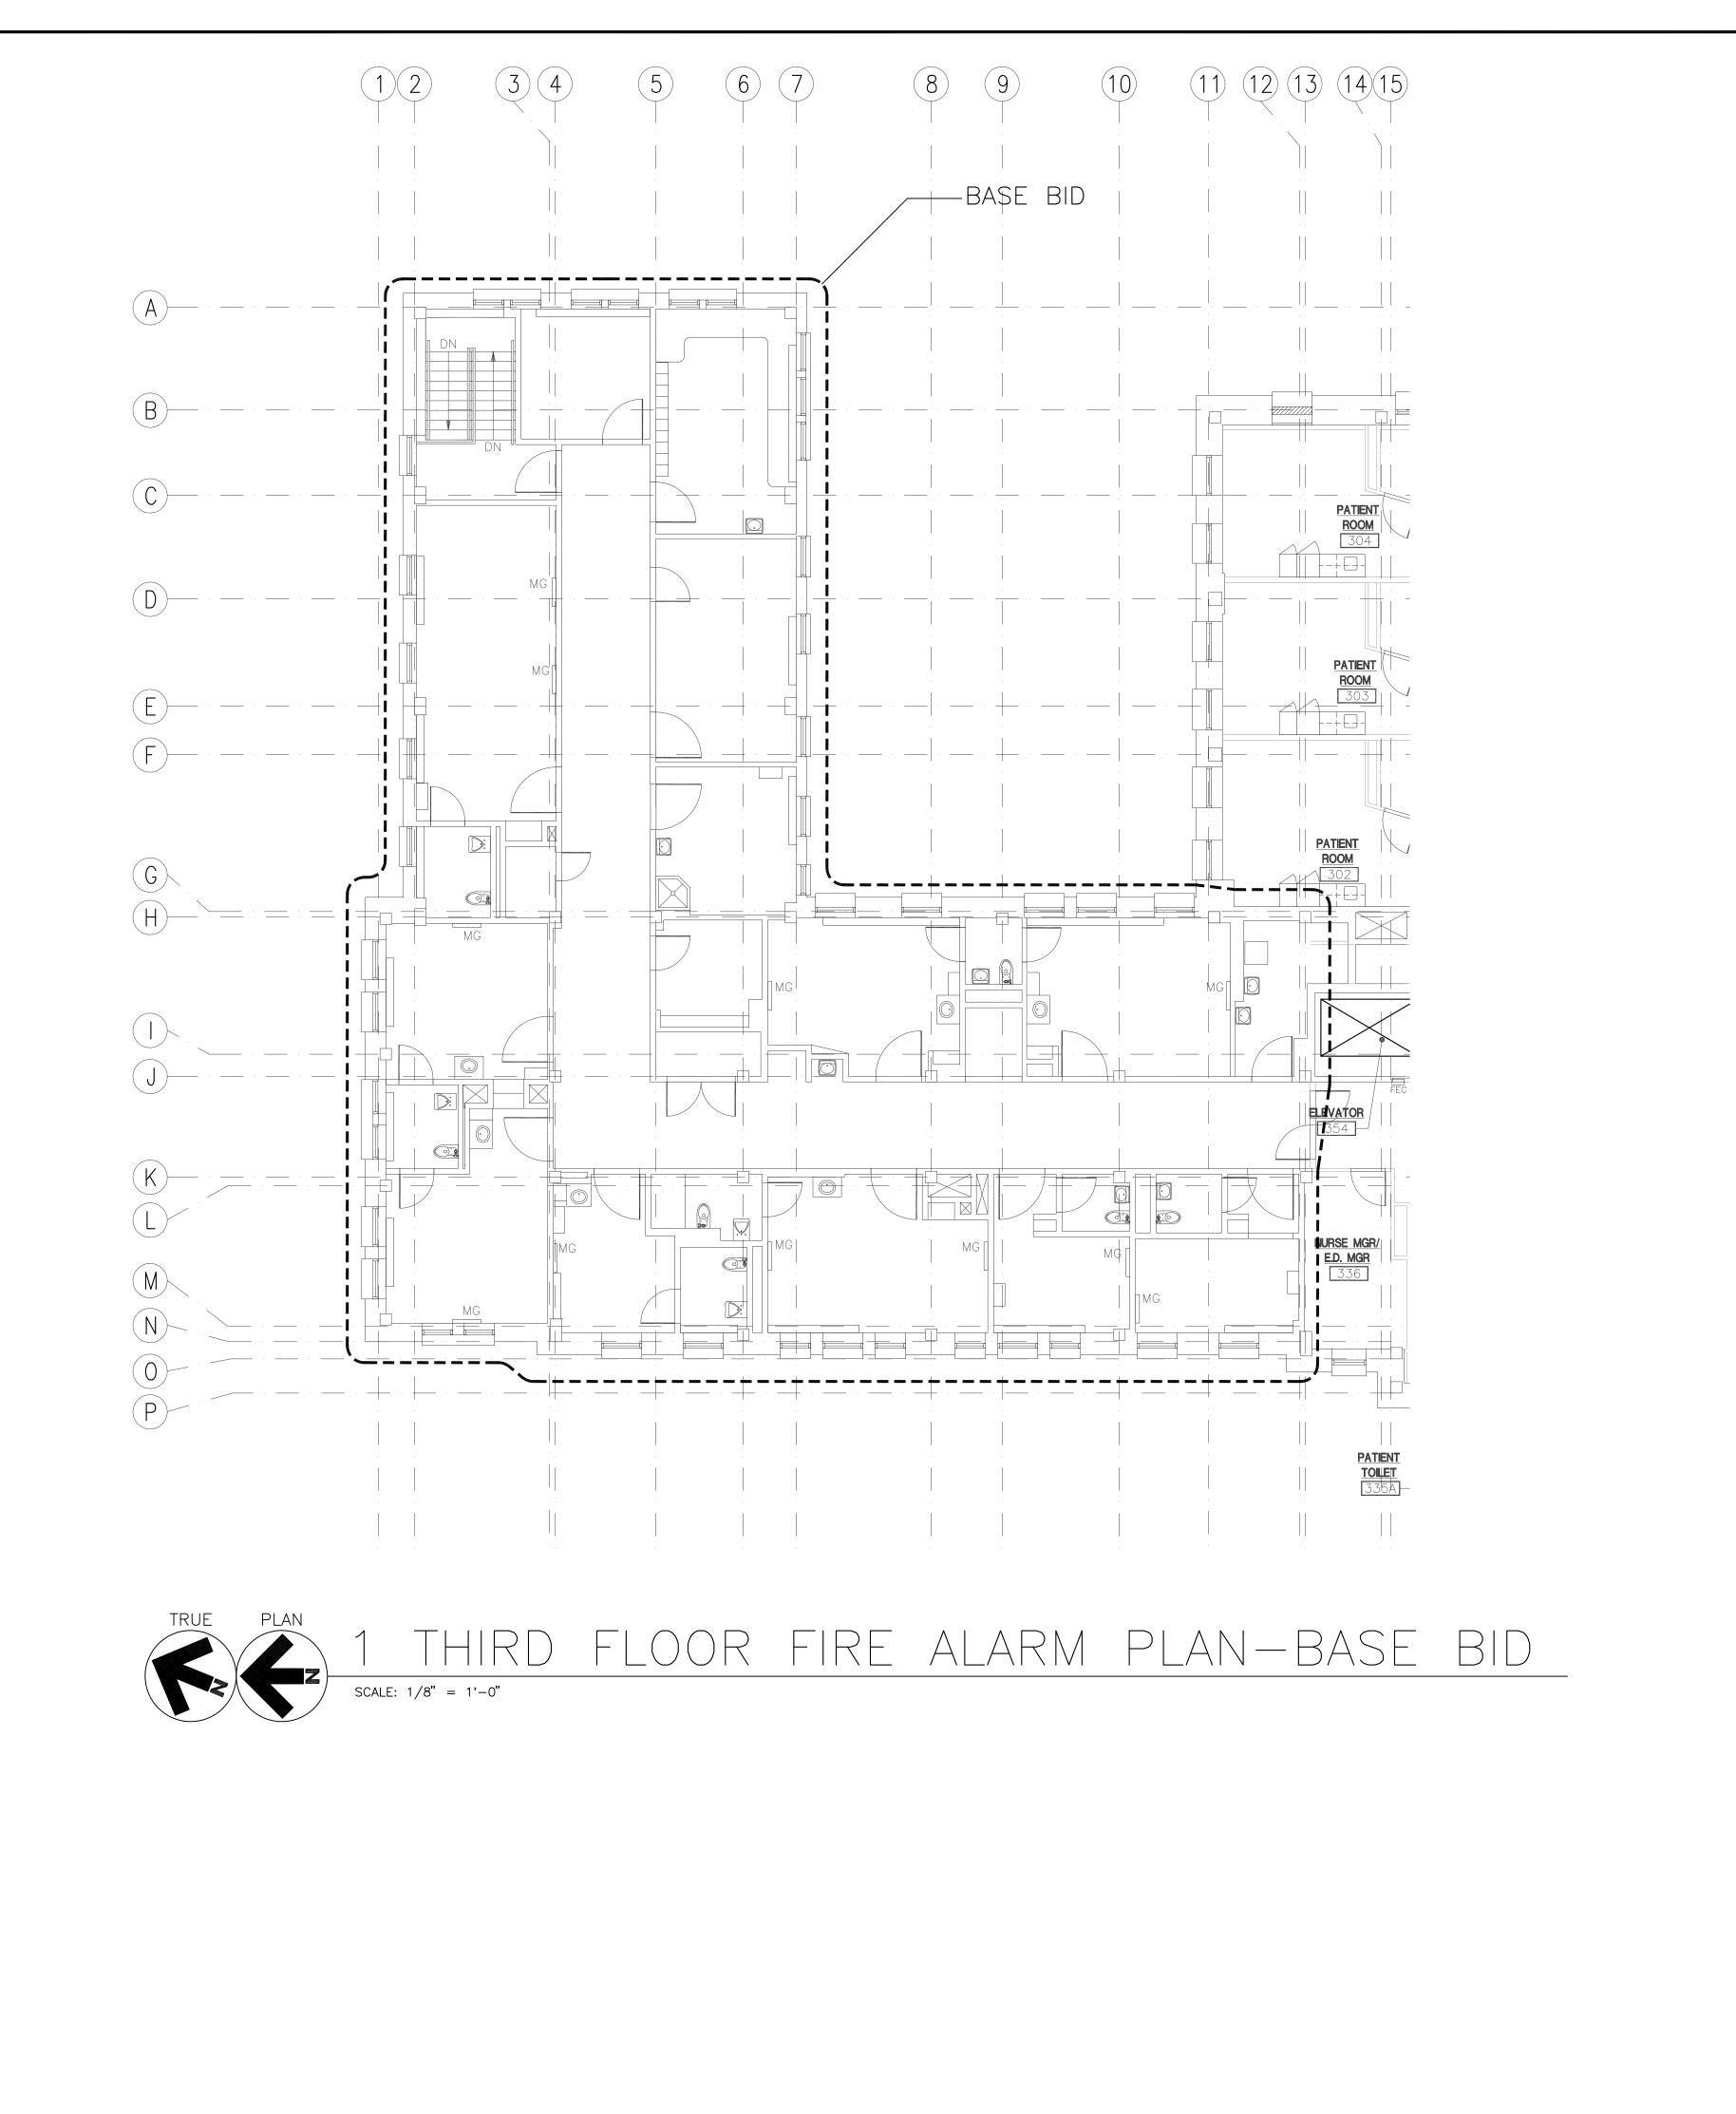


CAD FILE NAME: 531-320_FA2.3.DWG XREF FILE NAME: 531-320_30X42TLBK.DWG X67A3.DWG

PRAWING TITLE THIRD FLOOR FIRE ALARM PLAN APPROVED: CHIEF OF FACILITY MANAGEMENT SERVICE

DEPARTMENT OF VETERANS AFFAIRS

GENERAL NOTES:



GENERAL NOTES:

A. ALL ELECTRICAL WORK SHALL BE CLOSELY COORDINATED WITH THE CONTRACTORS PHASING OF THE PROJECT. COORDINATE ALL FIRE ALARM

WORK WITH ALL OTHER TRADES. B. THIS IS A MULTI-OCCUPANCY CLASSIFICATION WITH AN OCCUPANT LOAD OF LESS THAN 500 OR MORE THAN 100 PERSONS ABOVE OR BELOW THE

LOWEST LEVEL OF EXIT DISCHARGE. A FULL VISUAL NOTIFICATION SYSTEM IS NOT REQUIRED.

D. FIRE ALARM SYSTEM SHALL HAVE SPARE CAPACITY FOR ADDITIONS AND/OR MODIFICATION TO NOTIFICATION APPLIANCE CIRCUITS AND INITIATING

C. MANUAL PULL STATIONS SHALL BE INSTALLED PER NFPA 101-18.3.

PER NFPA 72 REQUIREMENTS. F. SEPARATE 120V POWER CIRCUITS ARE TO BE USED FOR DUCT SMOKE DETECTORS (IN-DUCT OR SAMPLING TUBE TYPE). DO NOT CONNECT TO THE 120V POWER CIRCUIT FOR THE CIRCUITS FOR DAMPERS & DOOR HOLDERS, OR THE CIRCUITS FOR POWER EXTENDER PANELS.

E. NOTIFICATION APPLIANCES (AUDIBLE AND VISUAL) SHALL BE SYNCHRONIZED

G. SHOP DRAWINGS SHALL BE APPROVED BY THE AUTHORITY HAVING JURISDICTION (AHJ) PRIOR TO THE INSTALLATION OF ANY CONDUIT OR COMPONENT. A SET OF APPROVED PLANS SHALL BE MAINTAINED AT THE JOB SITE AT ALL TIMES.

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I. FIRE ALARM SYSTEM BOXES AND CONDUIT IN AREAS NOT WITHIN PUBLIC VIEW SHALL BE PAINTED RED OR OTHERWISE MARKED AS REQUIRED BY NFPA 72. ALL FIRE ALARM EQUIPMENT IN PUBLIC VIEW IS TO BE PROVIDED WITH THE MANUFACTURER APPLIED CUSTOM COLOR DESIGNATED BY THE ARCHITECT.

J. COORDINATE WITH MECHANICAL CONTRACTOR REGARDING DUCT DETECTORS. IF DUCT DETECTORS ARE REQUIRED, THEY SHALL HAVE AN ACCESS / MAINTENANCE HATCH PER NFPA 72. ENSURE CONNECTIONS TO THE EXISTING FIRE ALARM CONTROL PANEL MEET NFPA 72 REQUIREMENTS. DUCT DETECTORS TO BE POWERED BY OTHERS (NOT FROM THE FACP).

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L. CONTRACTOR SHALL COORDINATE WITH CAMPUS SYSTEM DURING THE DESIGN PHASE AND PROVIDE A FIRE ALARM SYSTEM THAT IS PEER TO PEER AND NETWORKABLE WITH THE EXISTING SYSTEM.

M. FIRE ALARM CONTROL PANEL AND ASSOCIATED EQUIPMENT THAT REQUIRES 120V SHALL BE ON A DEDICATED BRANCH CIRCUIT, BE A LOCK-ON TYPE BREAKER THAT IS RED AND BE ON THE GENERATOR BACK UP SYSTEM. N. THE SAME CONTRACTOR (FIRE SENTRY) THAT PERFORMS THE INSTALLATION WILL PROVIDE THE OWNER / OWNERS REPRESENTATIVE WITH INSTRUCTION AS HOW TO MANAGE/CONTROL/AND PROGRAM THE INSTALLED FIRE ALARM SYSTEM.

SHEET NOTES:

THESE ENGINEERED DRAWINGS ARE TO DEFINE THE DESIGN CONCEPT FOR WORKING PLAN PREPARATION BY OTHERS. FIRE ALARM CONTRACTOR SHALL PROVIDE A COMPLETE SET OF SHOP DRAWINGS FOR TENANT IMPROVEMENTS ADDRESSES, WIRING DIAGRAMS, BATTERY CALCULATIONS, I/O MATRIX, ONE LINE DIAGRAM, SUBMITTALS, EXISTING SYSTEM TIE IN DIAGRAMS AND EQUIPMENT COMPATIBILITY DOCUMENTATION. CONTRACTOR IS RESPONSIBLE TO OBTAIN A SEALED LETTER OF ACCEPTANCE, FROM THE ENGINEER, CERTIFYING THE SHOP DRAWINGS ARE IN ACCORDANCE WITH THE DESIGN CONCEPT. REVIEW LETTER SHALL BE SUBMITTED WITH WORKING PLANS TO APPROPRIATE JURISDICTIONAL AUTHORITIES AND INTERESTED PARTIES.

APPROVED: MEDICAL CENTER DIRECTOR

AMY K. DOCKTER, P.E. C.W. MOORE PLAZA 250 S. 5TH ST BOISE, IDAHO PHONE: 208-343-4635 FAX: 208-343-1858 THESE DRAWINGS AND SPECIFICATIONS, AS INSTRUMENTS OF SERVICE, ARE AND SHALL REMAIN THE PROPERTY OF THE ARCHITECT / ENGINEER WHETHER THE PROJECT FOR WHICH THEY ARE MADE IS EXECUTED OR NOT. THESE

CAD FILE NAME: 531-320_FA2.3A.DWG XREF FILE NAME: 531-320_30X42TLBK.DWG X67A3.DWG

PRAWING TITLE BOISE VAMC THIRD FLOOR BUILDING 67 EXPANSION FIRE ALARM PLAN BASE BID APPROVED: CHIEF OF FACILITY MANAGEMENT SERVICE BUILDING NUMBER DRAWN

531-320 DRAWING NO. RJL

DWG 190 OF 191

AKD

VAMC BOISE, IDAHO

DEPARTMENT OF VETERANS AFFAIRS

CSH6A

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NOTE: THIS IS A TYPICAL RISER LAYOUT AND IS SCHEMATIC IN NATURE. NOT ALL DEVICES ARE SHOWN. FIRE ALARM CONTRACTOR TO ENSURE ALL NEW DEVICES ARE INCLUDED ON THE RISER. PROVIDE COMPLETE RISER LAYOUT ON SHOP DRAWINGS.

TYPICAL COMBINATION HORN/STROBE -STROBE ONLY -- ADDRESS IDENTIFICATION FLOW AND TAMPER SWITCHES AT FIRE ALARM INDICATING CIRCUIT ----SPRINKLER RISER ALARM INITIATING CIRCUIT — FIRE ALARM -TYPICAL ADDRESSABLE ANNUNCIATING PANEL ---MONITOR/CONTROL MODULE UNITS FAAP TYPICAL PULL STATION FACP 3/4"C. TO TELEPHONE—— \rightarrow 3/4"C. TO DEDICATED 120V CIRCUIT BACKBOARD (IDENTIFY CIRCUIT NUMBER) FIRE ALARM CONTROL PANEL IN -TELEPHONE / COMMUNICATIONS RM. ─BATTERY (24 HR)

FIRE ALARM RISER DIAGRAM NOTES:

1. REFER TO FLOOR PLAN FOR LOCATION AND QUANTITY OF DEVICES.

2. UNDER THE ACTIVATION OF SPRINKLER FLOW, SMOKE DETECTOR AND/OR ANY HVAC UNIT DUCT SMOKE DETECTOR THE CONTROL PANEL SHALL SHUT—OFF HVAC UNITS.



NOTE: THIS IS A TYPICAL I/O
MATRIX AND IS SCHEMATIC IN
NATURE. NOT ALL INPUTS OR
OUTPUTS ARE SHOWN. FIRE ALARM
CONTRACTOR TO ENSURE ALL I/O
ARE INCLUDED. PROVIDE COMPLETE
I/O MATRIX ON SHOP DRAWINGS

ARE INCLUDED. PROVIDE COMPLETE I/O MATRIX ON SHOP DRAWINGS											VATERFLOW DRS RS IN RATED WALLS SE OF STATUS & ADDRESS LOCATION		
			; 	 	; 	; 				; 			COMMON AUDIBLE SUPERVISORY SIGNAL AT FACP AND ANNUNCIATORS JATE COMMON AUDIBLE TROUBLE SIGNAL AT FACP AND ANNUNCIATORS
SYSTEM INPUTS		/ /	/	1/	1/	/	1/ 1/	/ /	1/	1/	1/	/ /	
FIRE ALARM AC POWER FAILURE-FACP & ALL POWER PANELS							X			X		X	
FIRE ALARM SYSTEM LOW BATTERY-FACP & ALL POWER PANELS							X			X		X	
OPEN CIRCUIT-FACP & ALL POWER PANELS							X			X		X	
GROUND FAULT-FACP & ALL POWER PANELS							X			X		X	
NOTIFICATION APPLIANCE SHORT CIRCUIT-FACP & ALL POWER PANELS							X			X		X	
MANUAL PULL STATION	X	X			X			X	X	<u> </u>	X		
SMOKE DETECTORS — ELEVATOR MACHINE ROOM	X	X	X		X			X		X	X		
SMOKE DETECTORS — ELEVATOR LOBBIES	X	X	X		X			X		X	X		
HEAT DETECTORS — ELEVATOR MACHINE ROOM	X	X		X	X			X		X	X		
SMOKE DETECTORS — ABOVE FACP & POWER PANELS AND FOR EGRESS	X	X			X			X		<u> </u>	X		
WET SYSTEM FLOW SWITCH	X	Х			X		<u> </u>	< X	X	X	X		
TAMPER SWITCHES ON SPRINKLER CONTROL VALVES						X				X		X	
TAMPER SWITCH ON KNOX BOX						X				X		X	
DUCT SMOKE DETECTORS - SAMPLING TUBE FOR HVAC SMOKE CONTROL INPUT		X				<u> </u>				X		X	

SYSTEM OUTPUTS

ACTUATE ALL SPEAKERS & STROBES

| | | | ELEVATOR RECALL

DELAYED EGRESS UNLOCKING SEQUENCE

HVAC SHUTDOWN FOR SMOKE CONTROL


| | ELEVATOR POWER SHUNT TRIP

TRANSMIT FIRE ALARM SIGNAL TO SUPERVISING STATION


TRANSMIT SUPERVISORY SIGNAL TO MONITORING SERVICE



NOTE: THIS IS A TYPICAL
EQUIPMENT SCHEDULE AND IS
SCHEMATIC IN NATURE. NOT ALL
EQUIPMENT IS SHOWN. FIRE ALARM
CONTRACTOR TO ENSURE ALL
EQUIPMENT IS INCLUDED. PROVIDE
COMPETE EQUIPMENT SCHEDULE ON
SHOP DRAWINGS

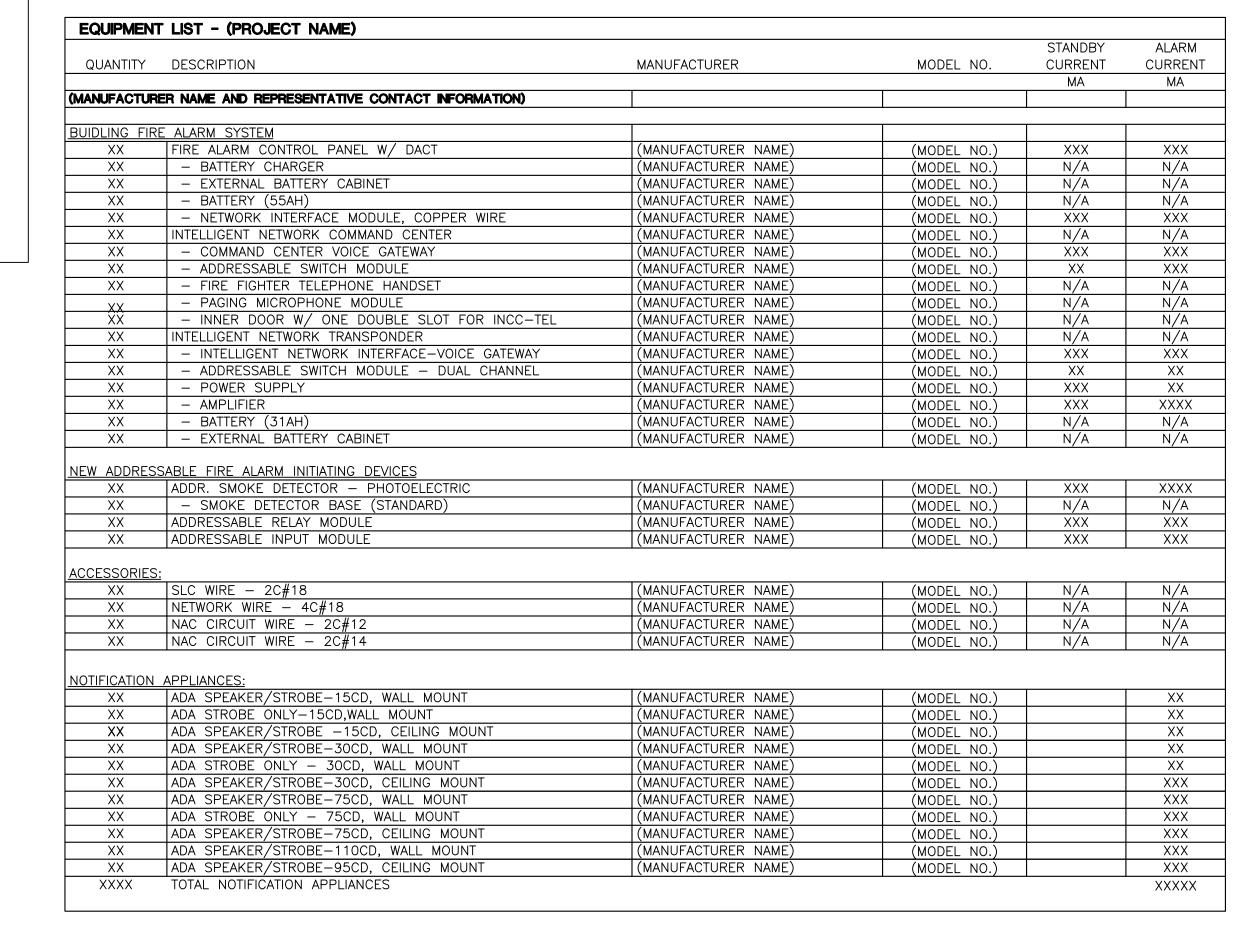

2 EQUIPMENT LIST FOR FIRE ALARM EQUIPMENT SCALE: NONE

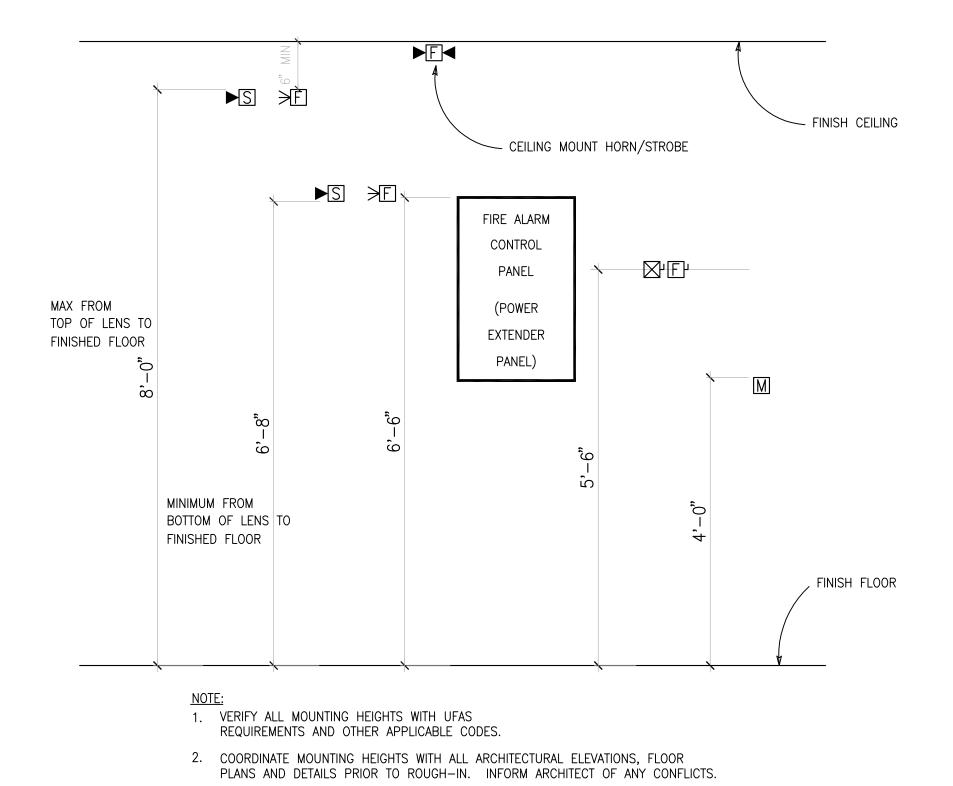

4 MOUNTING HEIGHT DETAIL

scale: None

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PAIN K. DOCKTER


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XREF FILE NAME:

531-320_30X42TLBK.DWG

FIRE ALARM RISER DIAGRAM AND DETAILS	11	PROJECT TITLE BOISE VAMC BUILDING 67 EXPANSION								
APPROVED: CHIEF OF FACILITY MANAGEMENT SERVICE	BUILDING NUMBER 67	CHECKED AKD	DRAWN RJL	DRAWING N						
APPROVED: MEDICAL CENTER DIRECTOR	LOCATION	LOCATION								



NS DATE CSH64
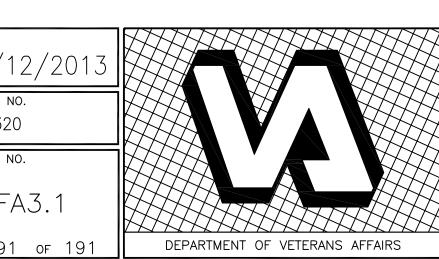
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